TRI-CITY SURFACE PARKING LOT

4002 Vista Way Oceanside, CA 92056

PROJECT SUBMITTAL

Contacts

MiechowskiCJ@TCMC.com

Graphic Symbols

∖ View Name

A101 / 1/8" = 1'-0"

WALL SECTION / DETAIL

STRUCTURAL GRID LINE

REFERENCES DOOR SCHEDULE

101) — DOOR NUMBER

REFERENCES COLOR AND FINISH SCHEDULE

PT-X **←** FINISH

EXTERIOR ELEVATION

INTERIOR ELEVATION

BUILDING SYSTEM

<u>MATCHLINE</u>

W XXX-X

FIRE EXTINGUISHERS

NUMBER ON SHEET

DRAWING TITLE

└── DRAWING SCALE

SHEET NUMBER

- SHEET ON WHICH THE

- DRAWING NUMBER

- SHEET ON WHICH THE

ELEVATION OCCURS

- DRAWING NUMBER

SHEET ON WHICH THE

A5 = 5 LB ABC EXTINGUISHER

A10 = 10 LB ABC EXTINGUISHER

S = SURFACE MOUNTED CABINET

SH = SURFACE MOUNTED HOOK

SR = SEMI RECESSED CABINET ∟R = RECESSED CABINET

EX = EXISTING EXTINGUISHER

SH____EX = EXISTING CABINET OR HOOK

TYPE PER SCHEDULE

ELEVATION OCCURS

REFERENCES BUILDING SYSTEMS TYPE SCHEDULE


SCHEDULE

EXTENT OF SYSTEM ----

 $\frac{1}{1} \frac{\frac{1}{A101}}{\frac{1}{A101}} - - - - -$

FINISHES / FURNITURE / EQUIPMENT

SECTION OCCURS

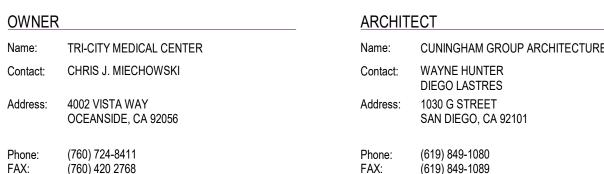

Name:	CUNINGHAM GROUP ARCHITECTURE, INC.
Contact:	WAYNE HUNTER DIEGO LASTRES
Address:	1030 G STREET SAN DIEGO, CA 92101

E-Mail: SPAK@CUNINGHAM.COM

- DRAWING NUMBER

SHEET ON WHICH THE

DRAWING NUMBER

SHEET ON WHICH THE

PARTITION TYPE PER SCHEDULE

FRAME TYPE PER SCHEDULE

- FRAME TYPE PER SCHEDULE

PER SCHEDULE

PROJECT NORTH

TRUE NORTH

PARTITION MODIFIER

DETAIL OCCURS

SECTION OCCURS

BUILDING SECTION

DETAIL

ROOM

ROOM NAME

INTERIOR PARTITION

WINDOW FRAME TYPE

LOUVER FRAME TYPE

FLOOR FINISH TRANSITION

COMPASS ROSE

REFERENCES COLOR AND FINISH SCHEDULE

HEIGHT/ELEVATION BENCHMARKS

REFERENCES SHEET KEYNOTE LEGEND

DATUMS - WORKPOINT AND CENTER POINT

FIXTURE / EQUIPMENT (ELEVATION)

D = SMOKE DETECT E = ELECTRICAL

ACCESSIBLE PARKING STALLS (ADA)

C = CLOCK

S = SPEAKER

LT = THERMOSTAT


D = SMOKE DETECTOR

101 **→** ROOM NUMBER

REFERENCES PARTITION TYPE SCHEDULE

REFERENCES WINDOW FRAME TYPE SCHEDULE(S)

REFERENCES LOUVER FRAME TYPE SCHEDULE(S)

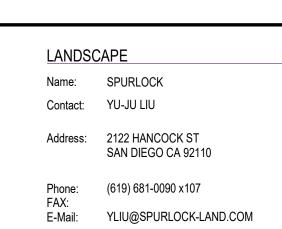

Abbreviations

ACA ACOUSTICAL CEILING ACCESSORY

ADA AMERICANS WITH DISABILITIES ACT

ACG ACOUSTICAL CEILING GRID

ACT ACOUSTICAL CEILING TILE

AFF ABOVE FINISHED FLOOR

ALT ALTERNATIVE / ALTERNATE

AWP ACOUSTICAL WALL PANEL

AWT ACOUSTICAL WALL TREATMENT

BO() BOTTOM OF: DECK, BEAM, STEEL

ACP ACOUSTICAL CEILING PANEL

AB AIR BARRIER

AC ACCESSORY

ACR ACRYLIC

ADH ADHERE

ALUM ALUMINUM

ARCH ARCHITECT

ART ARTWORK

BLKG BLOCKING

BRG BEARING

CB CHALK BOARD

CC COLUMN COVER

CCT CUBLICLE CURTAIN

INSTALLED

CG CORNER GUARD

CJ CONTROL JOINT

CL CENTER LINE

CLR CLEAR(ANCE)

CONC CONCRETE

CPTB CARPET BASE

DIA DIAMETER

DIV DIVISION

DN DOWN

DWGS DRAWINGS

(E) / EXIST EXISTING

CK CORK

CCF COLUMN COVER FINISH

CF CUSTOM FABRICATION

CFF CONCRETE FLOOR FINISH

CMP COMPOSITE METAL PANEL

CMU CONCRETE MASONRY UNIT

CONT CONTINUOUS / CONTINUE

CPT CARPET TILE OR BROADLOOM

CT CERAMIC / PORCELAIN TILE

CP COMPOSITE PANEL

CTB CERAMIC TILE BASE

DEC DECORATIVE CONCRETE

DF DRINKING FOUNTAIN

DRP DRAPERY/CURTAINS

E-FIXT ELECTRICAL FIXTURE

EJ EXPANSION JOINT

EL ELEVATION

ELEC ELECTRIC(AL)

ELEV ELEVATOR

EXP EXPOSED

EXT EXTERIOR

FD FLOOR DRAIN

FIN FINISH

GA GAUGE

GALV GALVANIZED

GB GYPSUM BOARD

GL GLASS, GLAZING GMU GLAZED MASONRY UNIT

GT GLASS TILE

HB HOSE BIBB

GYP GYPSUM

GC GENERAL CONTRACTOR

GFRP GLASS REINFORCED PLASTIC

FLR FLOOR(ING)

FOS FACE OF STUD

EQ EQUAL

DWP DECORATIVE WALL PANEL

EWC ELECTRICAL WATER COOLER

FAB FABRIC, NON-UPHOLSTERY

FAF FLUID APPLIED FLOORING

FE / FEC FIRE EXTINGUISHER (CABINET)

FF&E FIXTURES, FURNISHINGS & EQUIPMENT

FRP FIBERGLASS REINFORCED WALL PANEL

GFRC GLASS FIBER REINFORCED CONCRETE

GFRG GLASS FIBER REINFORCED GYPSUM

FF / FFE FINISH FLOOR (ELEVATION)

FOEW FACE OF EXISTING WALL

CF/OI CONTRACTOR FURNISHED / OWNER

CGA CUNINGHAM GROUP ARCHITECTURE, INC.

BRK BRICK

AF ACCESS FLOOR



HDBD HARDBOARD

HDWD HARD WOOD

HM HOLLOW METAL

ID INSIDE DIAMETER

LLH LONG LEG HORIZONTAL

LLV LONG LEG VERTICLE

LMC LINEAR METAL CEILING

LWC LINEAR WOOD CEILING

MAT CARPET/WALK-OFF MAT

MDF MEDIUM DENSITY FIBERBOARD

MB MARKER BOARD

HSS HOLLOW STEEL SECTION

HDWR HARDWARE

INSUL INSULATION

INT INTERIOR

L-FIXT LIGHT FIXTURE

LAV LAVATORY

MAS MASONRY

MATL MATERIAL

MAX MAXIMUM

MECH MECHANICAL

MIN MINIMUM

MTD MOUNTED

MTLT METAL TRIM

MTL METAL

NOM NOMINAL

MG METAL GRATE

MIR MIRROR(ED)

MO MASONRY OPENING

NA NOT APPLICABLE

NIC NOT IN CONTRACT

NTS NOT TO SCALE

OC ON CENTER(S)

INSTALLED

OH OVERHEAD

P-FIXT PLUMBING FIXTURE

PLAM PLASTIC LAMINATE

PME PATCH TO MATCH EXISTING

PRV POWER ROOF VENTILATOR

PARTBD PARTICLEBOARD

OPNG OPENING

OZ OUNCE

PL PLATE

PNL PANEL

PLS PLASTER

PLY PLYWOOD

PREFIN PREFINISHED

PT PAINT(ED) PT EXT EXTERIOR PAINT

PV PLUMBING VENT

QTB QUARRY TILE BASE

RB RESILIENT BASE

REF REFERENCE / REFER TO

RF RESILIENT FLOORING

RD ROOF DRAIN

RMAT RECESSED MAT

RTU ROOF TOP UNIT

RO ROUGH OPENING

SC SEALED CONCRETE

SF SQUARE FOOT/FEET

SP SPECIALTY FINISH

SPT SPECIAL PAINT SS STAINLESS STEEL

SSF SOLID SURFACE

SCF SPECIAL CONCRETE FINISH

SFCS STRETCHED FABRIC CEILING SYSTEM

SMCS STRETCHED MEMBRANE CEILING SYSTEM

SFWS STRETCHED FABRIC WALL SYSTEM

SGFT STRUCTURAL GLAZED FACING TILE

SPF SPRAY POLYURETHANE FOAM

REQD REQUIRED

S SEAL

SE SEATING

SIM SIMILAR

ST STAIN

QT QUARRY TILE

QTY QUANTITY

R RISER

RAD RADIUS

OD OUTSIDE DIAMETER

OFRD OVERFLOW ROOF DRAIN

OFS OVERFLOW SCUPPER

OF/CI OWNER FURNISHED / CONTRACTOR

OF/OI OWNER FURNISHED / OWNER INSTALLED



STN STONE

STNB STONE BASE

STNT STONE TILE

SUSP SUSPENDED

SYST SYSTEM

T TREAD

TBL TABLE

TERR TERRAZZO

TYP TYPICAL

UNFIN UNFINISHED

VNR VENEER

UPH UPHOLSTERY

VIF VERIFY IN FIELD

VP VENEER PLASTER

VR VAPOR RETARDER

WB WEATHER BARRIER

WC WATER CLOSET

WCV WALL COVERING

WD BLK WOOD BLOCKING

WDF WOOD FLOORING

WDV WOOD VENEER

WPT WALL PROTECTION

WT WINDOW TREATMENT

NUMBER / POUND

XPS EXTRUDED POLYSTYRENE

WDB WOOD BASE

WDT WOOD TRIM

WP WORK POINT

WDW WINDOW

& AND

@ AT

WD WOOD

VSE VENEER SHELF ELEVATION

TB TACKBOARD

TERB TERRAZZO BASE

TERT TERRAZZO TILE

SV SHEET VINYL

SWF SPECIALTY WALL FINISH

T&G TONGUE AND GROOVE

TFC TEXTURED FINISH CEILING

PARAPET, STEEL, WALL

UNO UNLESS NOTED OTHERWISE

TP TOILET PARTITION

TS TRANSITION STRIP

TO(_) TOP OF: DECK, CONCRETE, BEAM,

STNF STONE FLOORING

STNV STONE VENEER

Project Description

THE PROJECT CONSISTS OF THE ADDITION OF 290 PARKING STALLS TO THE WEST OF THE EXISTING PARKING LOT AT TRI-CITY MEDICAL CENTER. WORK WILL INCLUDE GRADING, ASPHALT PAVING, GENERAL LANDSCAPING, SITE LIGHTING, AND THE CONSTRUCTION OF A DECORATIVE CONCRETE MASONRY WALL (CMU) ON THE NORTH SIDE FOR SCREENING THE PROPOSED PARKING LOT FROM THE RESIDENTIAL

General Notes

THE INTENT OF THE DRAWINGS AND SPECIFICATIONS IS TO RECONSTRUCT THE HOSPITAL BUILDING IN ACCORDANCE WITH THE 2016 EDITION OF TITLE 19 & 24, CALIFORNIA CODE OF REGULATIONS. SHOULD ANY CONDITION DEVELOP NOT COVERED BY THE CONTRACT DOCUMENTS WHEREIN THE FINISHED WORK WILL NOT COMPLY WITH SAID TITLE 19 & 24, CALIFORNIA CODE OF REGULATIONS, A CHANGE ORDER DETAILING AND SPECIFYING THE REQUIRED WORK SHALL BE SUBMITTED TO AND APPROVED BY OSHPD BEFORE PROCEEDING

THIS PROJECT SHALL CONFORM TO THE FOLLOWING CODES AND REGULATIONS:

C.C.R. - CALIFORNIA CODE OF REGULATIONS TITLE 19 - PUBLIC SAFETY CODE TITLE 24 - CALIFORNIA BUILDING STANDARDS CODE

2016 CALIFORNIA ADMINISTRATIVE CODE (CAC), PART 1, TITLE 24, C.C.R. 2016 CALIFORNIA BUILDING CODE (CBC), PART 2, TITLE 24 C.C.R. BASED ON THE 2015 INTERNATIONAL BUILDING CODE (IBC) 2. ELECTRICAL CODES: 2016 CALIFORNIA ELECTRICAL CODE (CEC), PART 3, TITLE 24 C.C.R. BASED ON THE 2014 NATIONAL ELECTRICAL CODE (NEC)

3. MECHANICAL CODES: 2016 CALIFORNIA MECHANICAL CODE (CMC) PART 4, TITLE 24 C.C.R BASED ON THE 2015 UNIFORM MECHANICAL CODE (UMC) 4. PLUMBING CODES: 2016 CALIFORNIA PLUMBING CODE (CPC), PART 5, TITLE 24 C.C.R.

BASED ON THE 2015 UNIFORM PLUMBING CODE (UPC) 2016 CALIFORNIA FIRE CODE, PART 9, TITLE 24 C.C.R. 5. FIRE CODE:

ALL WORK AND MATERIALS SHALL BE IN ACCORDANCE WITH THESE STANDARDS AND ALL APPLICABLE LOCAL ORDINANCES. WHERE CODES CONFLICT, THE MORE RESTRICTIVE SHALL APPLY AS DETERMINED BY THE CODE

BASED ON THE 2015 INTERNATIONAL FIRE CODE (IFC)

CITY OF OCEANSIDE BUILDING DIVISION CONDITIONS:

1. APPLICABLE BUILDING CODES AND ORDINANCES SHALL BE BASED ON THE DATE OF SUBMITTAL FOR BUILDING DIVISION PLAN CHECK. PLANS SHALL REFLECT CURRENT CALIFORNIA BUILDING CODES.

2016 TRIENNIAL EDITION OF CALIFORNIA CODE OF REGULATIONS (CCR), TITLE 24 THE 2016 TRIENNIAL EDITION OF THE CALIFORNIA CODE OF REGULATIONS, TITLE 24 (CALIFORNIA BUILDING STANDARDS CODE) APPLIES TO ALL OCCUPANCIES THAT APPLIED FOR A BUILDING PERMIT ON OR AFTER JANUARY 1, 2017, AND REMAINS IN EFFECT UNTIL THE EFFECTIVE DATE OF THE 2019 TRIENNIAL EDITION WHICH THERE ARE 12 PARTS TO TITLE 24 AND THE APPLICABLE PARTS FOR MOST BUILDING DIVISION PERMIT APPLICATIONS ARE LISTED BELOW.

PART 2: THE 2016 CALIFORNIA BUILDING CODE (CBC). PART 2.5: THE 2016 CALIFORNIA RESIDENTIAL CODE (CRC). PART 3: THE 2016 CALIFORNIA ELECTRICAL CODE (CEC). PART 4: THE 2016 CALIFORNIA MECHANICAL CODE (CMC). PART 5: THE 2016 CALIFORNIA PLUMBING CODE (CPC). PART 6: THE 2016 CALIFORNIA ENERGY CODE PART 9: THE 2016 CALIFORNIA FIRE CODE (CFC)

PART 11: THE 2016 CALIFORNIA GREEN BUILDING STANDARDS CODE (CALGREEN CODE) THIS PART IS KNOWN AS THE CALIFORNIA GREEN BUILDING STANDARDS CODE, AND IT IS INTENDED THAT IT SHALL ALSO BE KNOWN AS

AMENDMENTS TO THE CITY OF OCEANSIDE ADMINISTRATIVE CODE FOR BUILDING REGULATIONS

SHALL COMPLY WITH ALL CURRENT CODE REQUIREMENTS PRIOR TO SUBMITTAL FOR BUILDING PLAN REVIEW. 3. COMPLIANCE WIRH THE FEDERAL CLEAN WATER ACT (BMP'S) SHALL BE DEMONSTRATED ON THE PLANS.

2. THE BUILDING PLANS FOR THIS PROJECT SHALL BE PREPARED BY A LICENSED ARCHITECT OR ENGINEER AND

4. ALL OUTDOOR LIGHTING SHALL MEET CHAPTER 39 OF THE CITY CODE (LIGHT POLLUTION ORDINANCE) AND SHALL BE SHIELDED APPROPRIATELY (FULL-CUT OFF FIXTURE).

5. SITE DEVELOPMENT, PARKING, ACCESS INTO BUILDINGS AND BUILDING INTERIORS SHALL COMPLY WITH ALL CURRENT STATE OF CALIFORNIA ACCESSIBILITY CODE. 6. THE DEVELOPER SHALL MONITOR, SUPERVISE AND CONTROL ALL BUILDING CONSTRUCTION AND SUPPORTIVE

ACTIVITIES SO AS TO PREVENT THESE ACTIVITIES FROM CAUSING A PUBLIC NUISANCE, INCLUDING, BUT NOT LIMITED TO. STRICT ADHERENCE TO THE FOLLOWING: a. BUILDING CONSTRUCTION WORK HOURS SHALL BE LIMITED TO BETWEEN Z A.M. AND 6 P.M. MONDAY

THROUGH FRIDAY, AND ON SATURDAY FROM Z A.M. TO 6 P.M. FOR WORK THAT IS NOT INHERENTLY NOISE-PRODUCING. EXAMPLES OF WORK NOT PERMITTED ON SATURDAY ARE CONCRETE AND GROUT POURS, ROOF NAILING AND ACTIVITIES OF SIMILAR NOISE-PRODUCING NATURE. NO WORK SHALL BE PERMITTED ON SUNDAYS AND FEDERAL HOLIDAYS (NEW YEAR'S DAY, MEMORIAL DAY, JULY 4TH, LABOR DAY, THANKSGIVING DAY, CHRISTMAS DAY) EXCEPT AS ALLOWED FOR EMERGENCY WORK UNDER THE PROVISIONS OF THE OCEANSIDE CITY CODE CHAPTER 38 (NOISE ORDINANCE).

b. THE CONSTRUCTION SITE SHALL BE KEPT REASONABLY FREE OF CONSTRUCTION DEBRIS AS SPECIFIED IN SECTION 13.17 OF THE OCEANSIDE CITY CODE. STORAGE OR DEBRIS IN APPROVED SOLID WASTE CONTAINERS SHALL BE CONSIDERED COMPLIANCE WITH THIS REQUIREMENT. SMALL AMOUNTS OF CONSTRUCTION DEBRIS MAY BE STORED ON SITE IN A NEAT, SAFE MANNER FOR SHORT PERIODS OF TIME PENDING DISPOSAL

Sheet Index



General

G002 TRAFFIC CONTROL PLAN - FOR REFERENCE ONLY

Architectural

C-001 CIVIL TITLE SHEET

Landscape

L1.04 IRRIGATION DETAIL

Electrical

E1.0 SITE LIGHTING & PHOTOMETRIC PLAN

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GROUP

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San Diego, CA 92101

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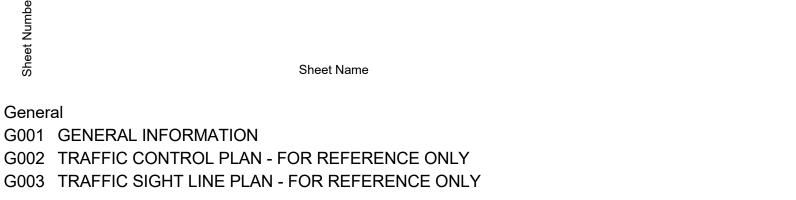
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Sheet Title

GENERAL

Sheet Number

	ALUMINUM		INSULATION - BATT
	BRICK		INSULATION - RIGID
	CERAMIC TILE / RESILIENT TILE		PARTICLE BOARD
4 4 4 4 4	CONCRETE - CAST-IN-PLACE		PLASTER / GROUT
	CONCRETE - PRECAST		PLYWOOD
	CONCRETE BLOCK	2 8	ROUGH LUMBER / WOOD FRAMING
	EARTH	2 8	WOOD BLOCKING
	EXISTING CONDITIONS		SAND / GRANULAR FILL
	WOOD - FINISHED		STONE
	GLASS		STEEL / STEEL STUD FRAMING
	GRAVEL/STONE FILL	4	TERRAZZO
	GVPSLIM WALL BOARD		



A100 OVERALL FLOOR PLAN

C-111 SCHEMATIC GRADING PLAN C-501 CIVIL DETAILS

L1.00 TREE SURVEY L1.01 SITE PLAN L1.02 PARKING ISLAND L1.03 IRRIGATION PLAN

> E01 SYMBOLS AND ABBREVIATIONS E02 PANEL SCHEDULE & SINGLELINE DIAGRAM


CONSTRUCTION

10/13/17 PR16-0409 TCMC PARKING LOT

Materials

	ALUMINUM		INSULATION - BATT
	BRICK		INSULATION - RIGID
	CERAMIC TILE / RESILIENT TILE		PARTICLE BOARD
4 4 4 4 4 4	CONCRETE - CAST-IN-PLACE		PLASTER / GROUT
	CONCRETE - PRECAST		PLYWOOD
	CONCRETE BLOCK	2 8	ROUGH LUMBER / WOOD FRAMING
	EARTH	2 8	WOOD BLOCKING
	EXISTING CONDITIONS		SAND / GRANULAR FILL
	WOOD - FINISHED		STONE
	GLASS		STEEL / STEEL STUD FRAMING
	GRAVEL/STONE FILL	4 4 4 4	TERRAZZO
	GYPSUM WALL BOARD		

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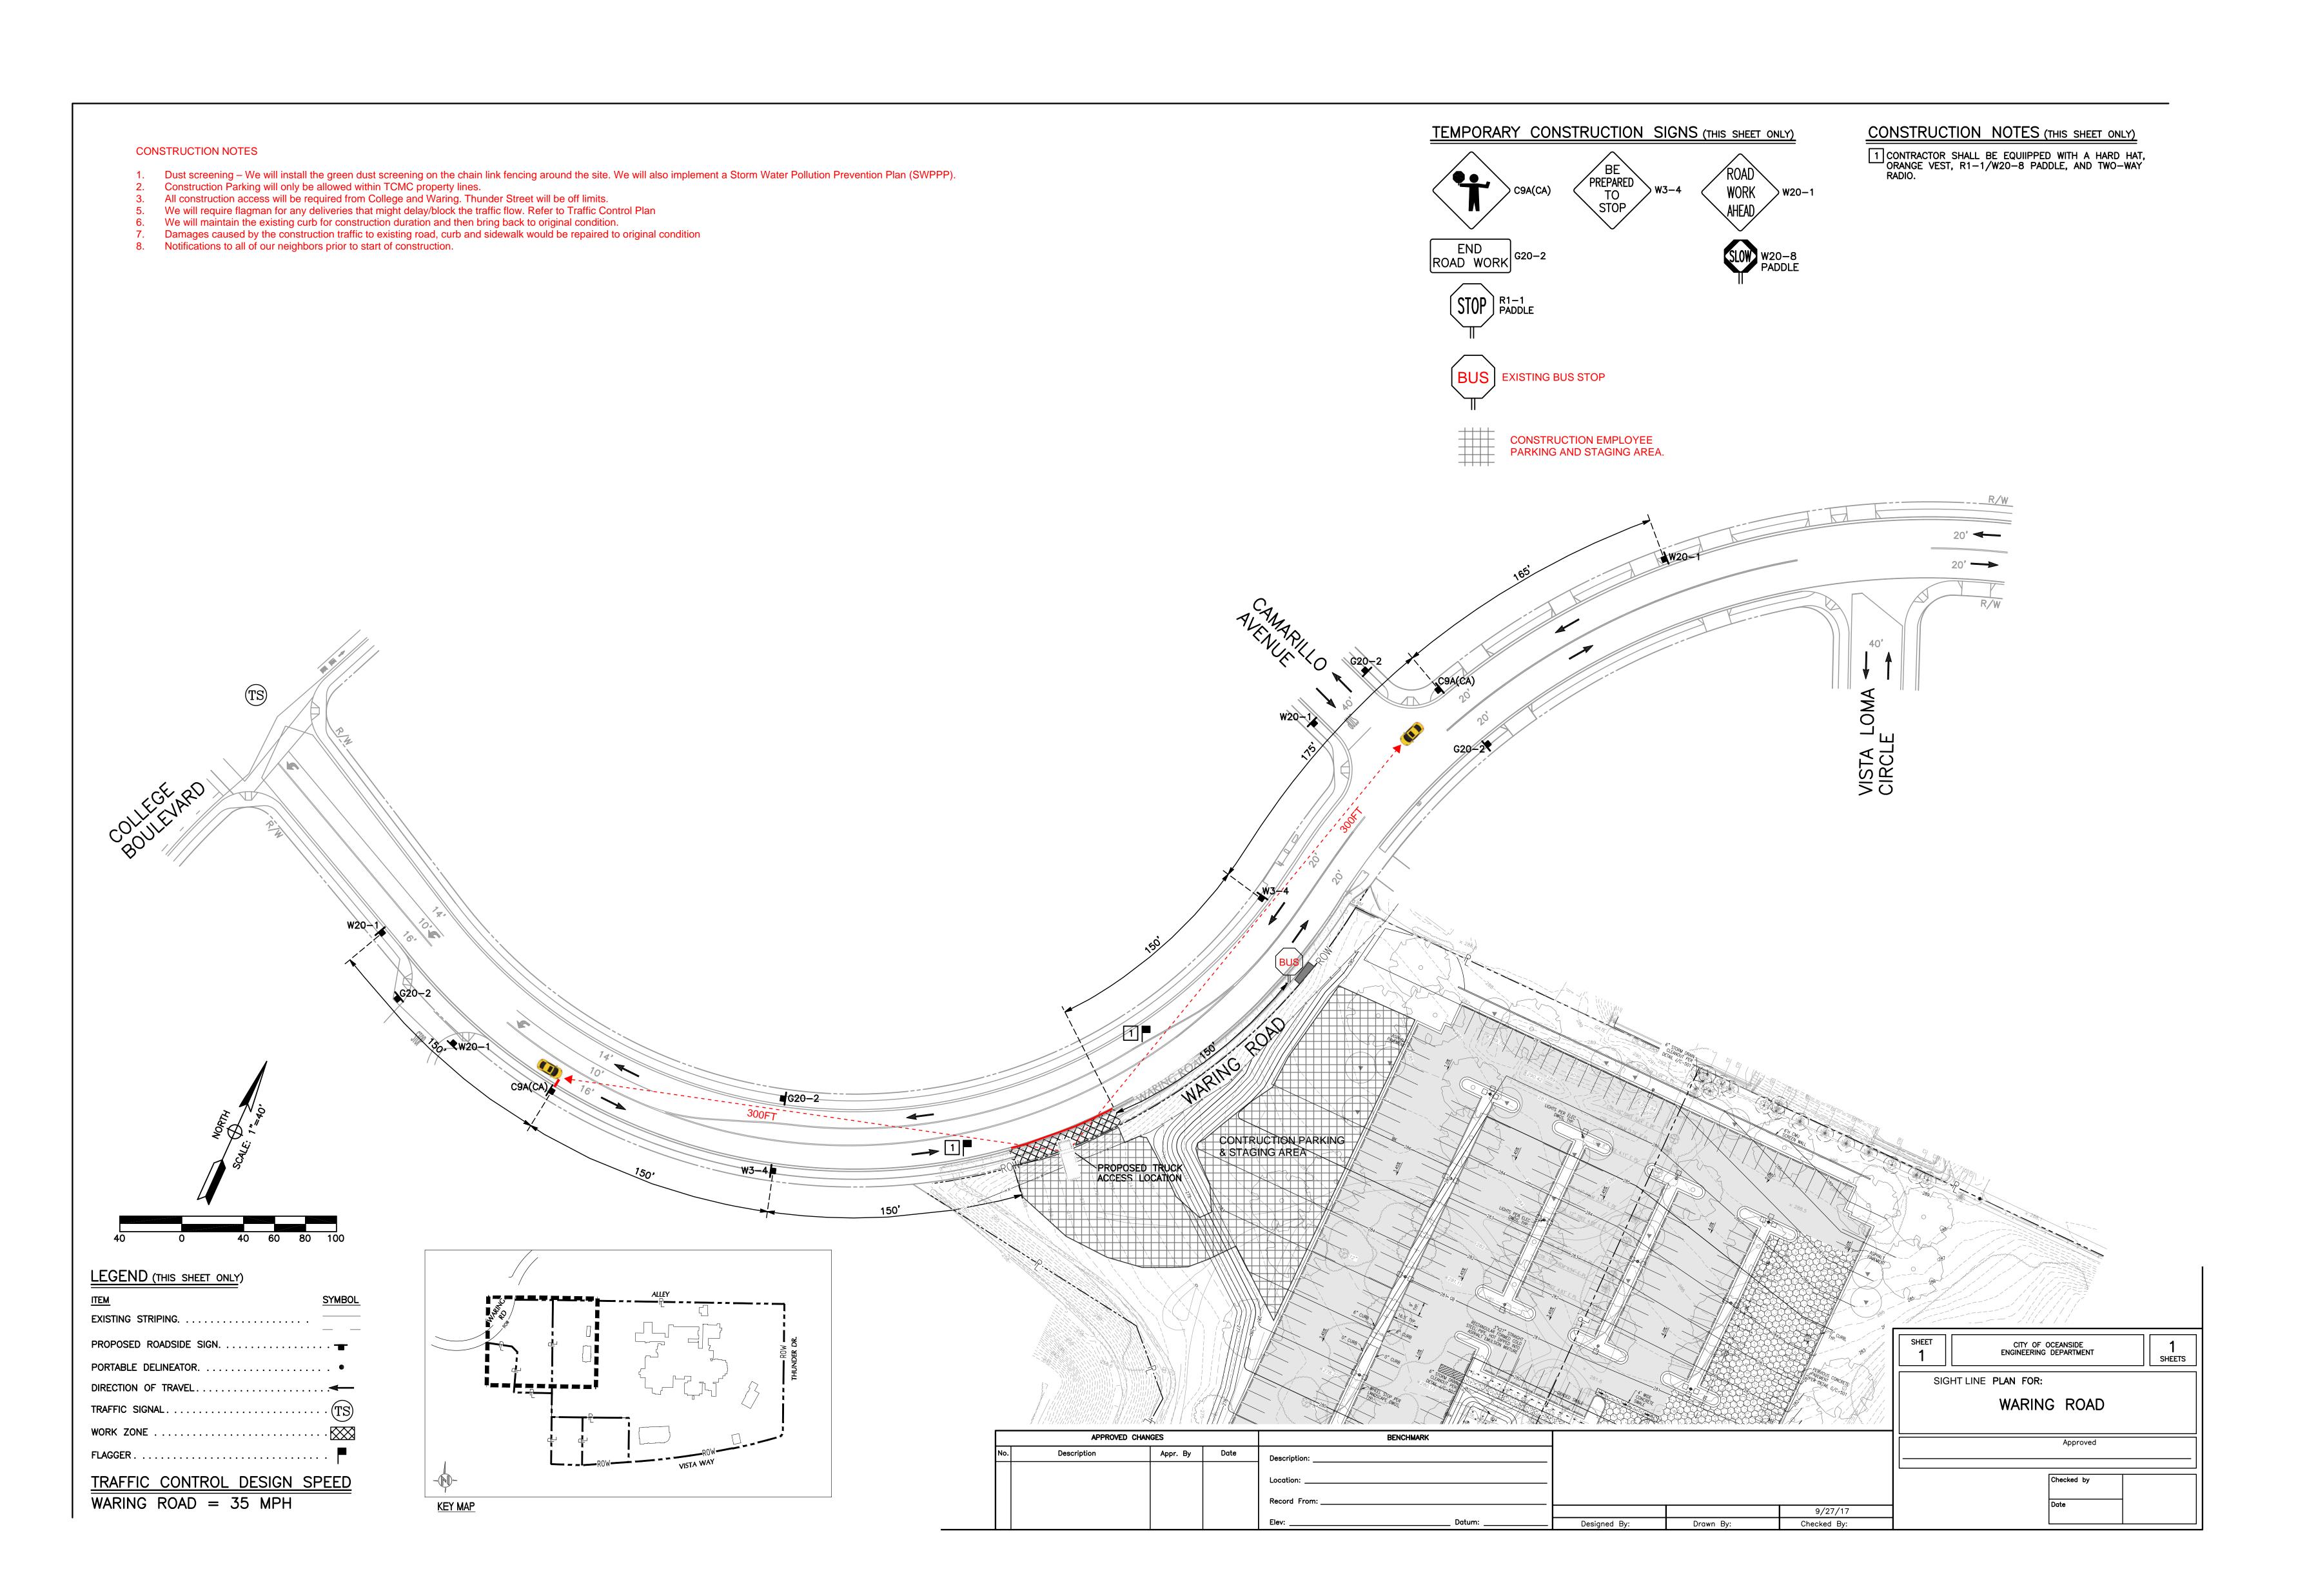
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TCMC PARKING LOT

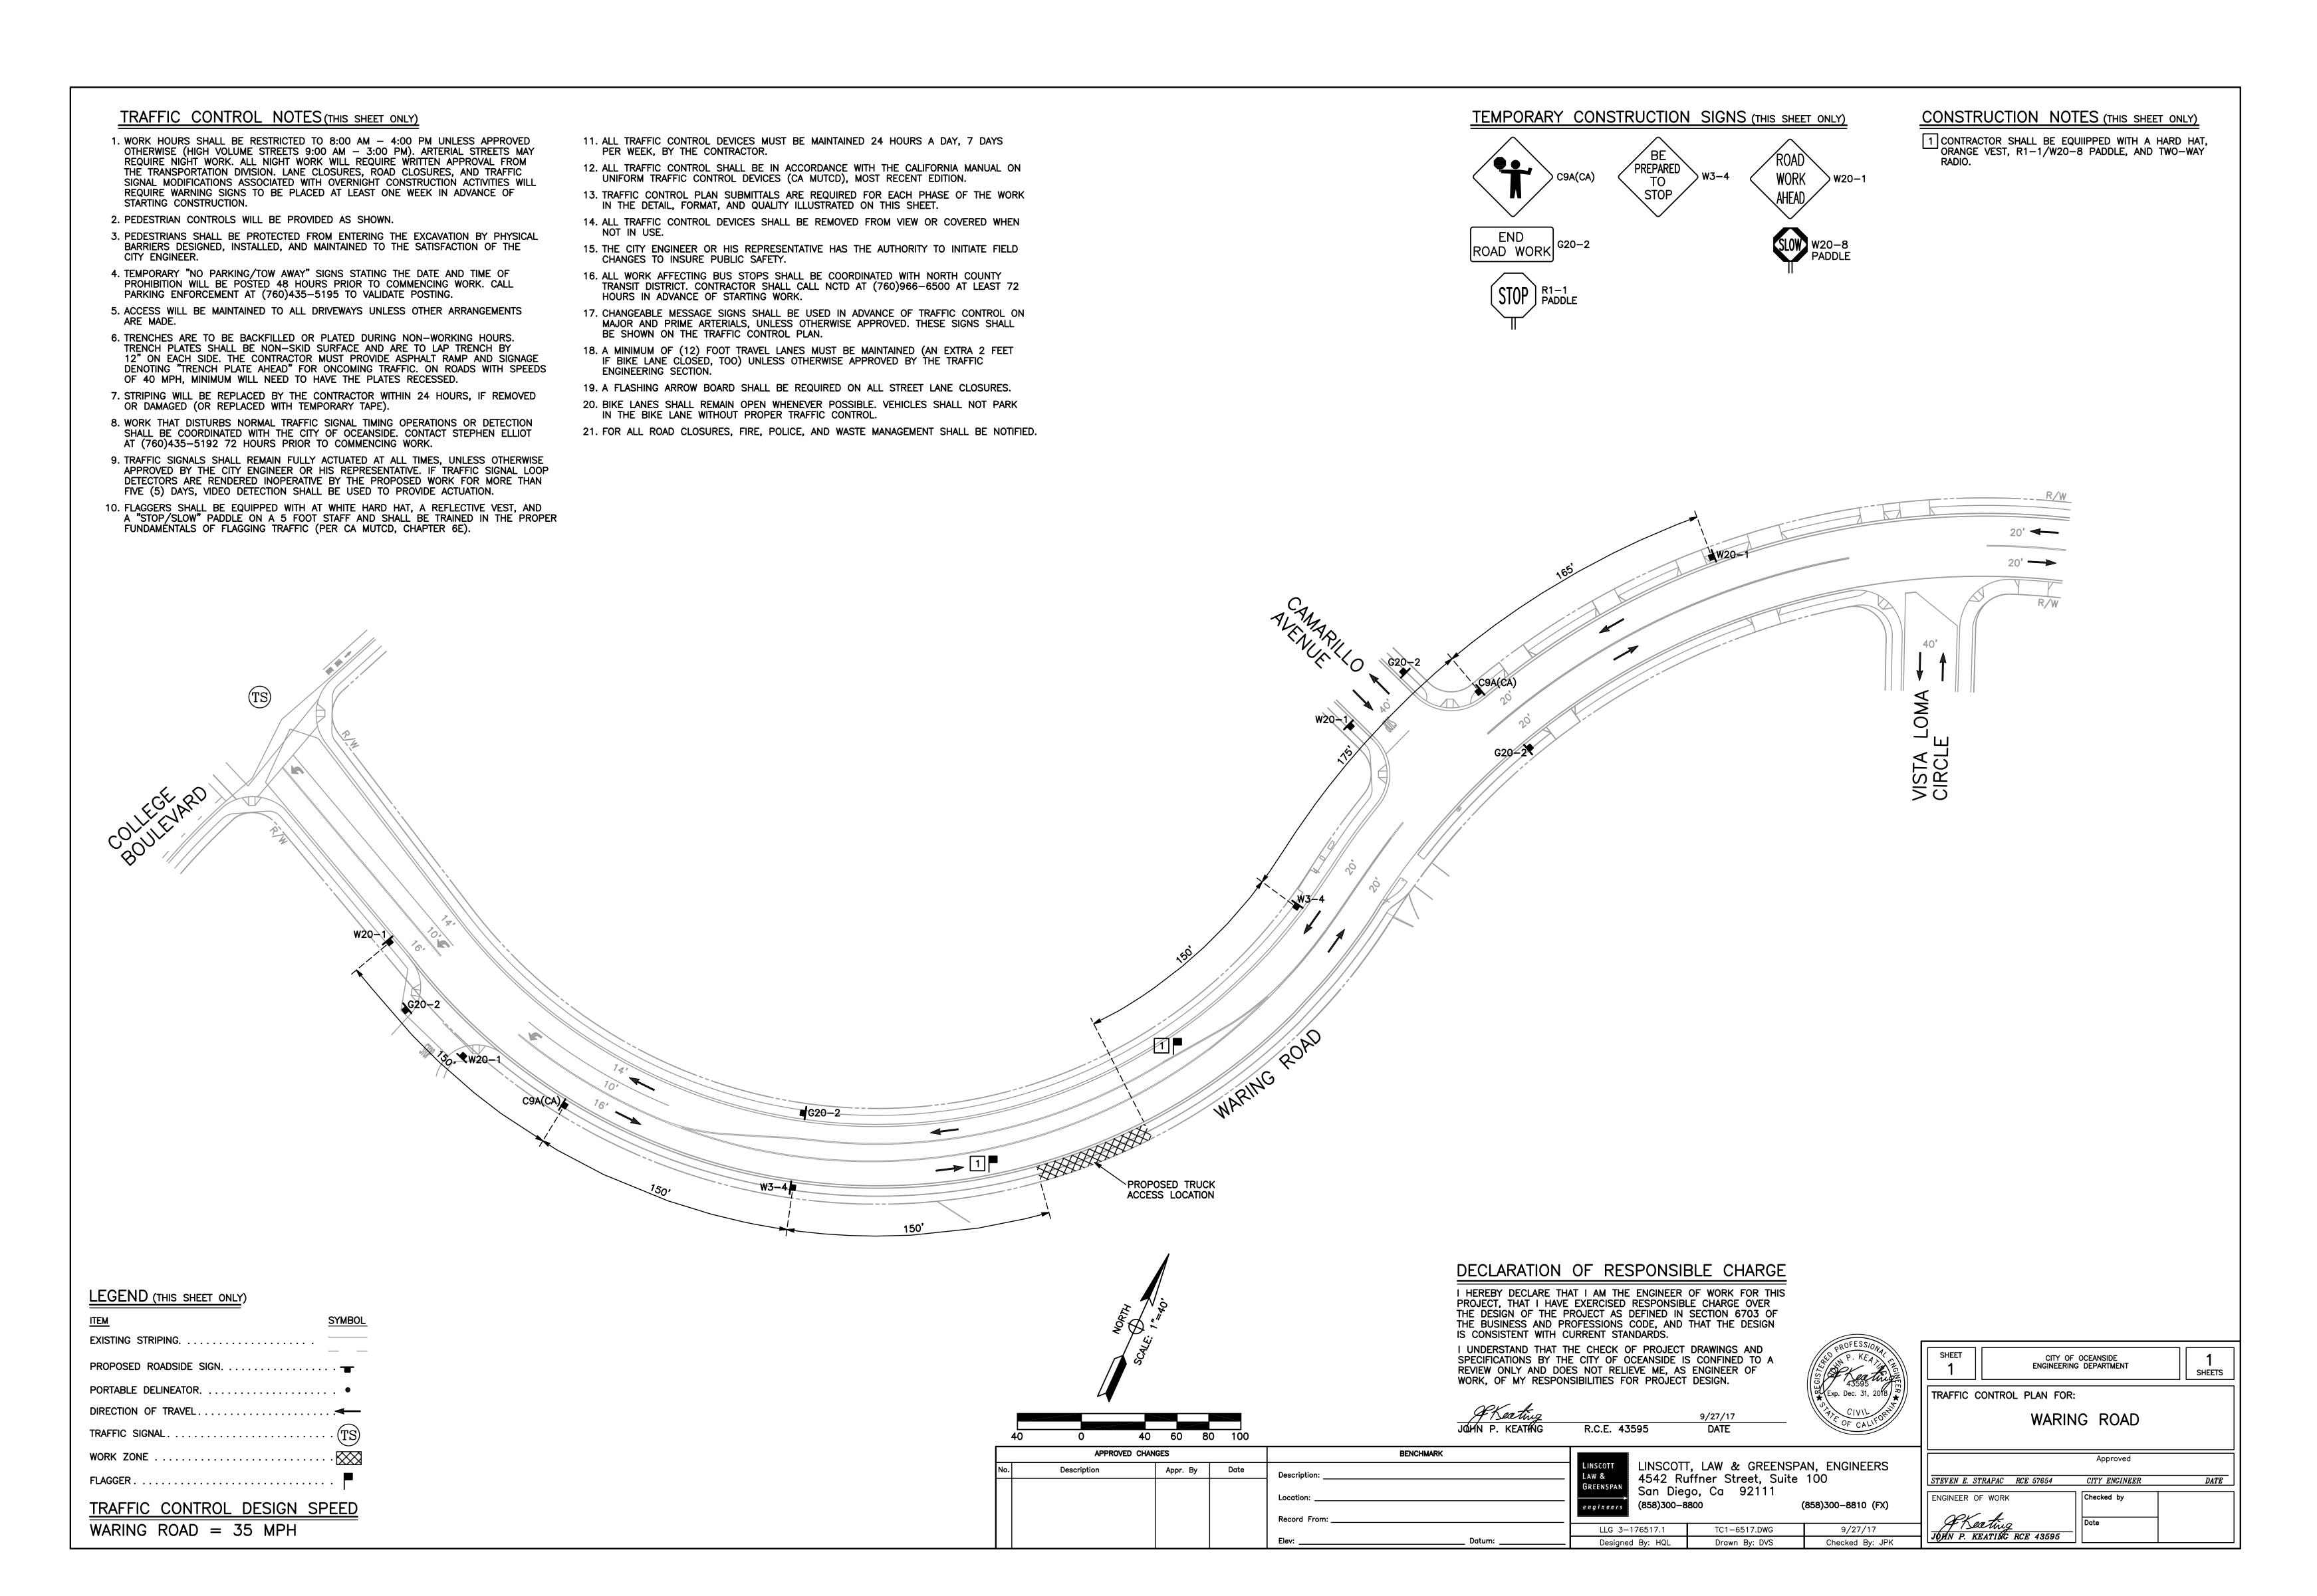Sheet Title
TRAFFIC CONTROL
PLAN - FOR
REFERENCE ONLY

Sheet Number

G002





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Project Title

TCMC PARKING LOT

Sheet Title
TRAFFIC SIGHT LINE
PLAN - FOR
REFERENCE ONLY

Sheet Number

G003

Block

All block must be type "N" grouted solid with f'_=1,500 psi.

Mix Requirements

Note: The use of plastic cement is not permitted in retaining walls.

1. The concrete mix for footings must meet a compressive strength of f'c=2,500 psi minimum.

The mortar mix must have a compressive strength equal to 1,800 psi minimum. One

possible mix contains the following proportions by volume:

1 part Portland cement

3½ parts sand

1/4 part hydrated lime or lime putty

3. Grout must have a compressive strength equal to 2,000 psi minimum. One possible mix contains the following proportions by volume:

1 part Portland cement

3 parts sand 2 parts pea gravel (3/8-inch aggregate)

Add water until pouring consistency is achieved without segregation of the grout constituents. Rod or vibrate immediately. Re-rod or re-vibrate grout about 10 minutes after pouring to ensure solid consolidation. Stop grout two (2) inches from top of masonry units when grouting of second lift is to be continued at another time.

Mortar Ke


To ensure proper bonding between the footing and the first course of block, a mortar key must be formed by embedding a flat 2 x 4 flush with and at the top of the freshly placed footing. It should be removed after the concrete has started to harden (about one (1) hour). A mortar key may be omitted if the first course of block is set into the fresh concrete when the footing is placed and a good bond is obtained.

Reinforcing Steel


Reinforcing Steel
Reinforcing steel must be deformed and comply with ASTM specification A615-85, Grade 40 or 60.
When one continuous bar cannot be used, a lap or splice of 24" is required.

Page 1 of 2


(Updated 07/2014)

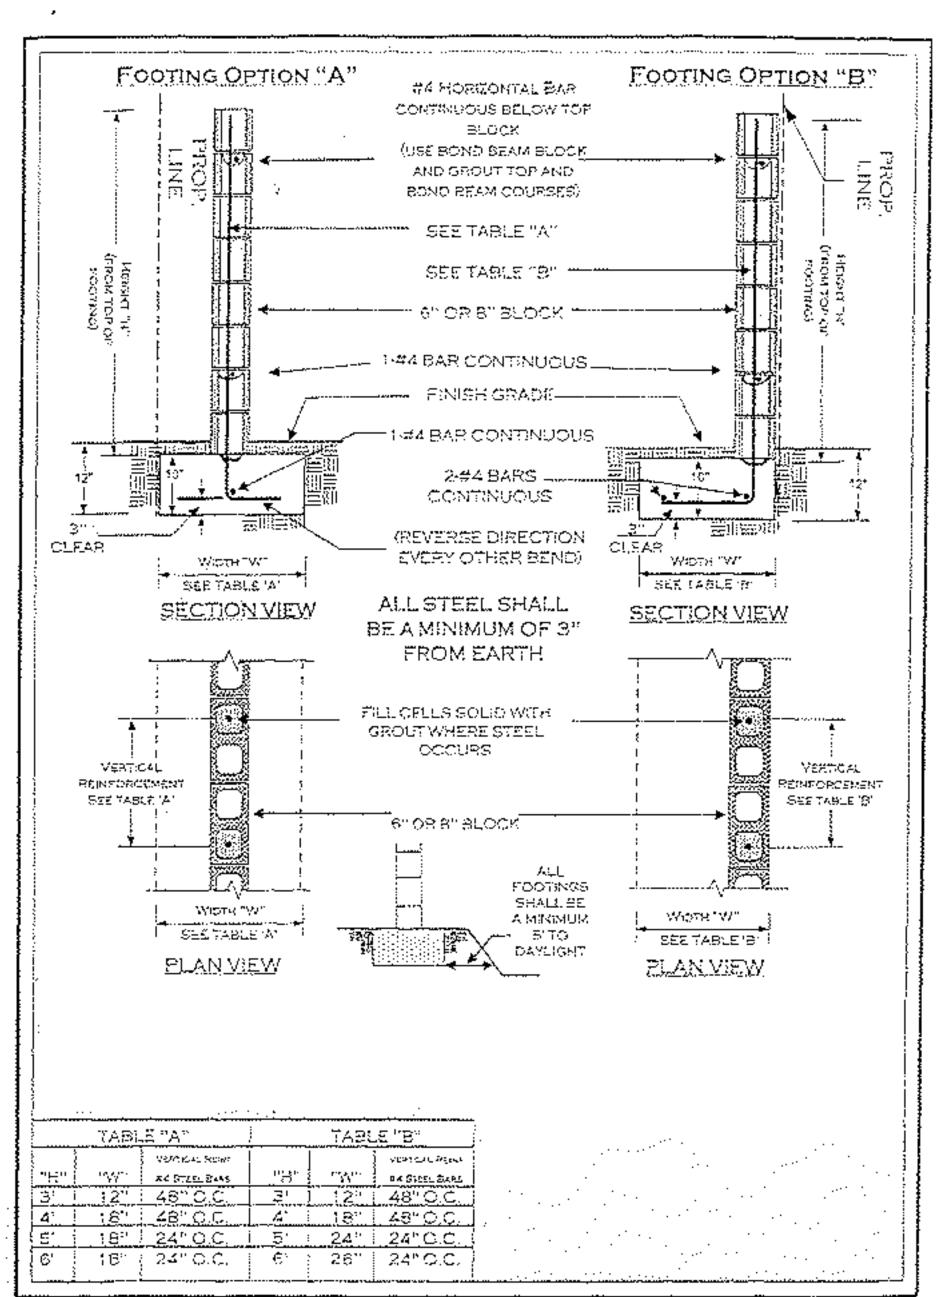

REFER TO DETAIL 1 SHEET L1.02

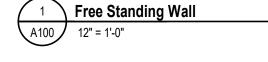

Page 2 of 2

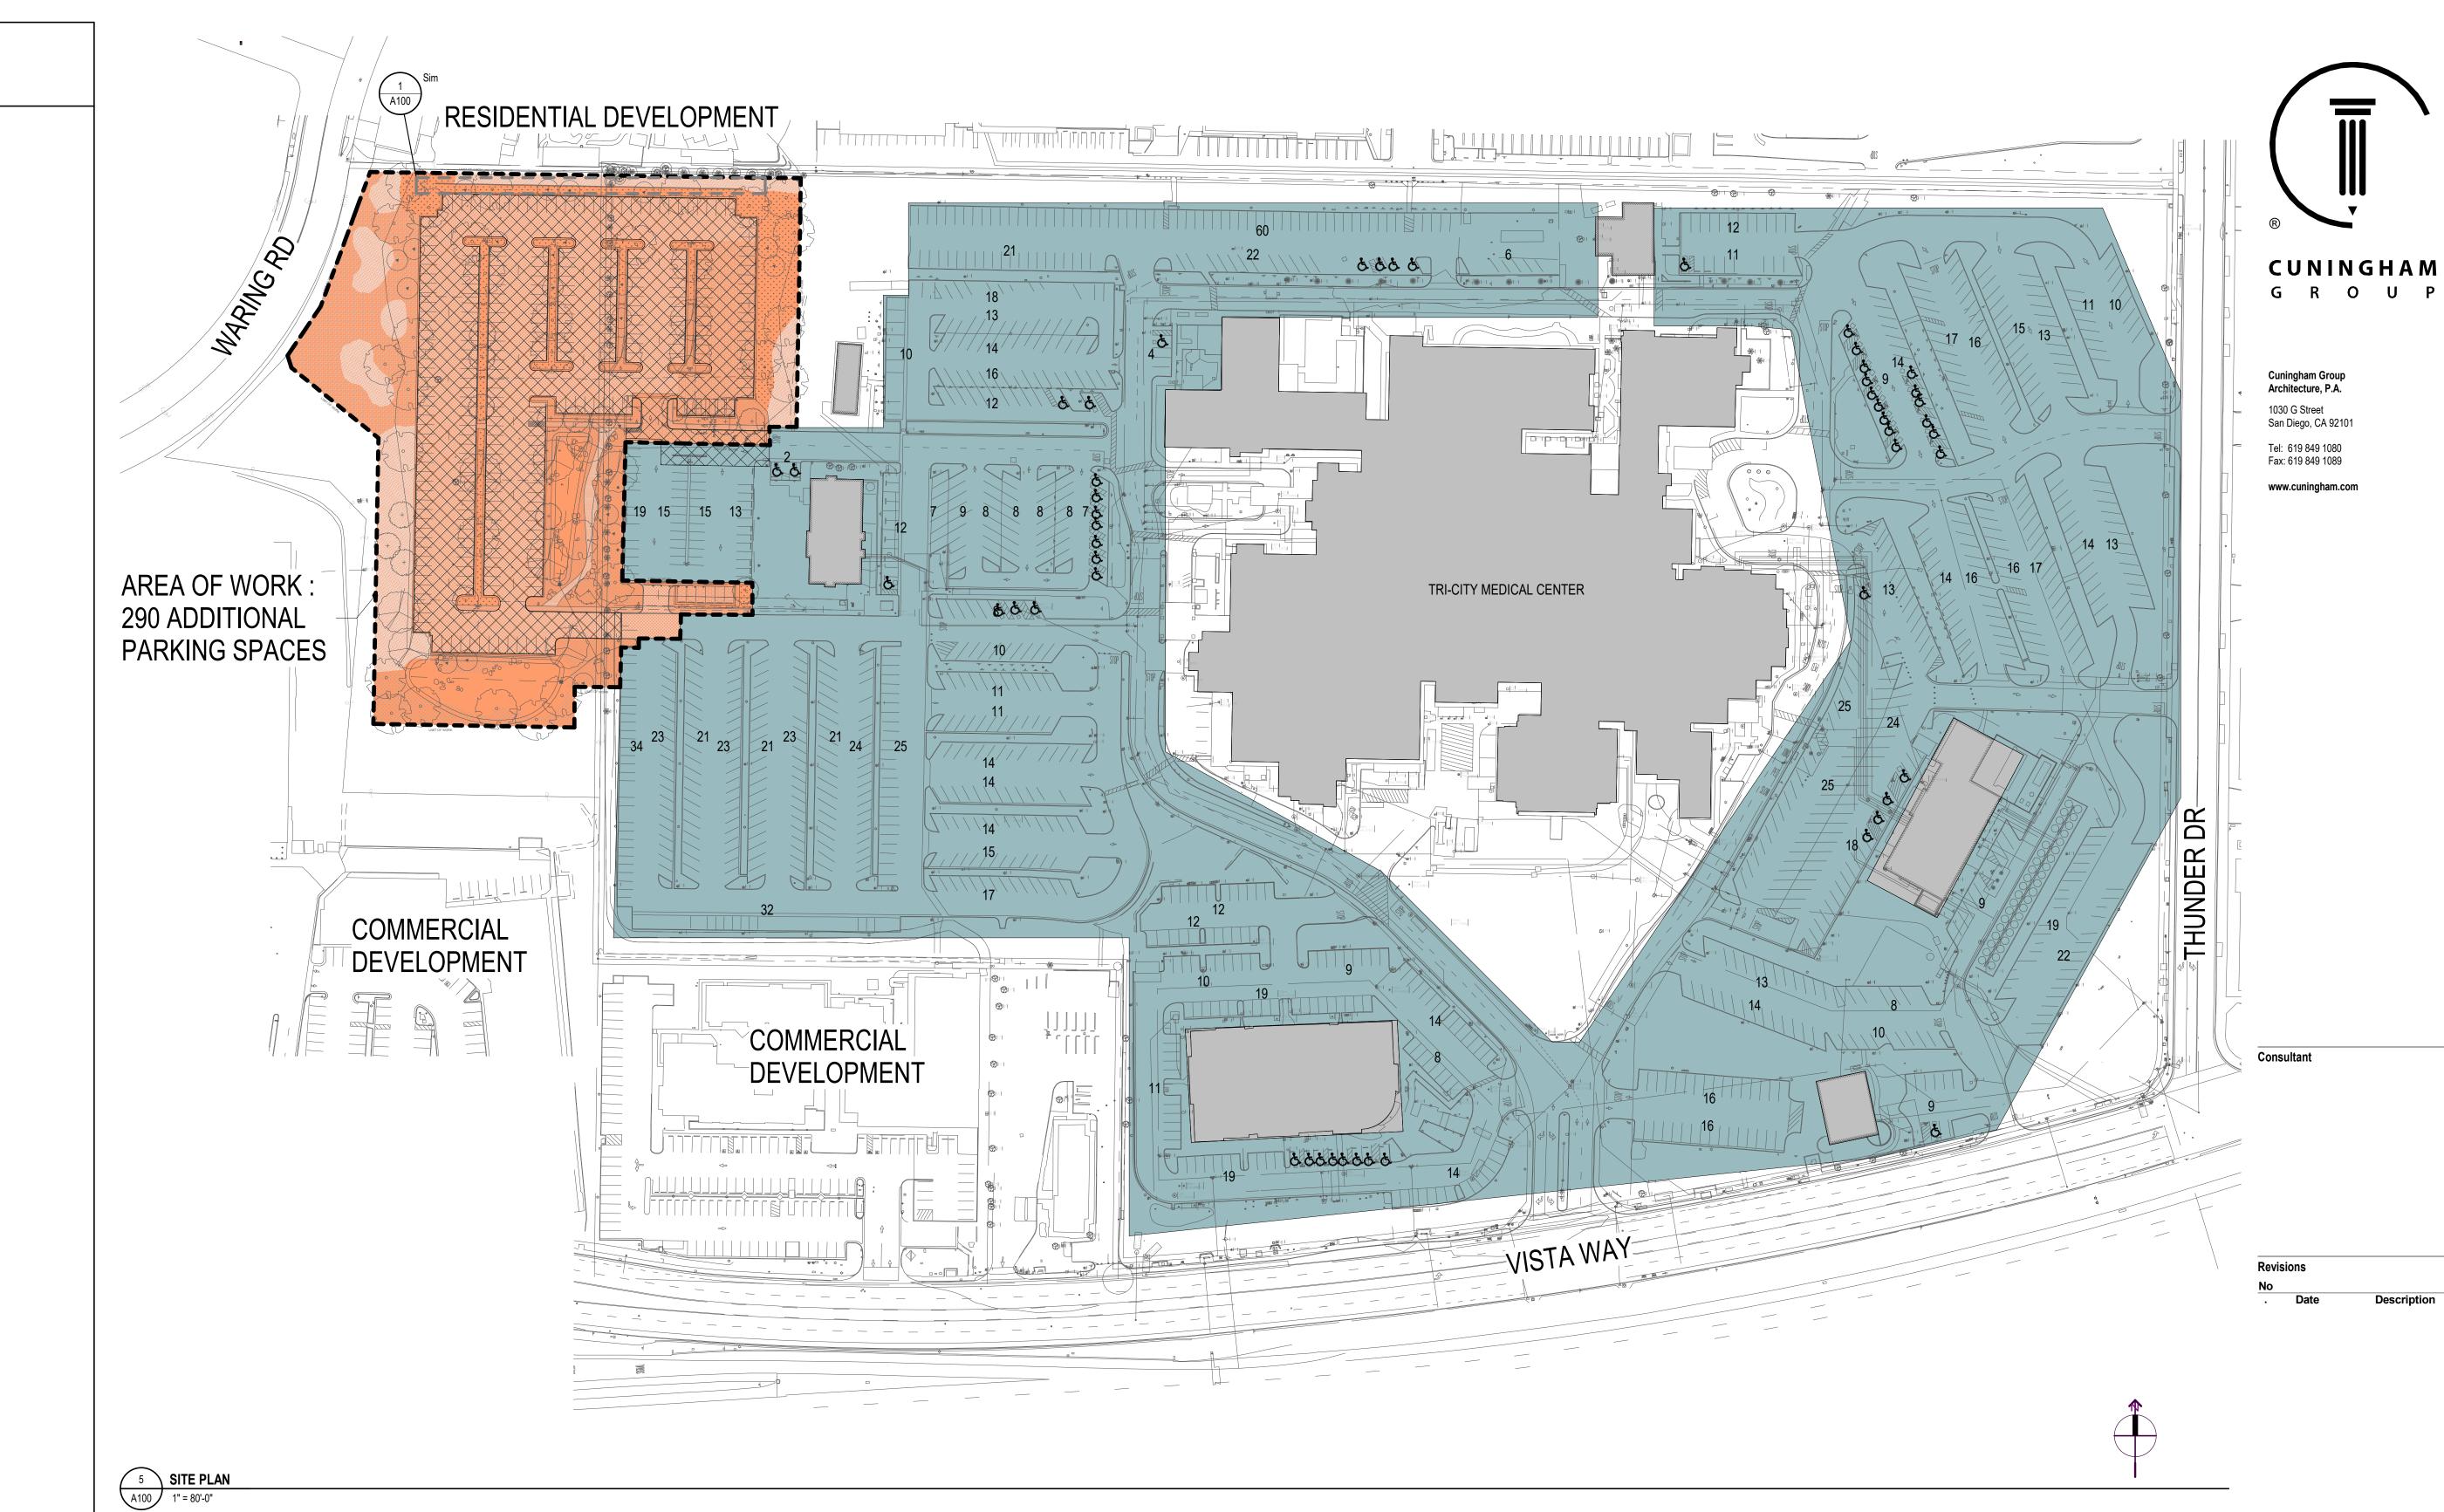

<u>LEGEND</u>

EXISTING BUILDINGS

EXISTING PARKING LOT

PROPOSED PARKING LOT

PROPOSED PARKING SPACES: 290

AREA OF WORK FOR

ACCESSIBLE PARKING REQUIREMENT CALCULATIONS

Total (E) Parking Spaces At Tri City Medical Center (TCMC): 1271 Spaces
Total Required Accessible Spaces per CBC Table 11B-208.2: 23 Spaces
Total (E) Accessible Spaces: 50 spaces

Additional Spaces in Proposed Parking Lot:

Total (E) Parking Spaces with Proposed Spaces:

Total Required Accessible parking spaces with additional parking:

290 Spaces

1561 Spaces

Total (E) Accessible Spaces:

50 spaces

Additional Required Accessible parking spaces:

0 Spaces

50 > 26 then No additional Accessible parking spaces are required in accordance with CBC Table 11B-208.2

Document Phase:

Date:

10/13/17

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Project Title

TCMC PARKING LOT

Sheet Title
OVERALL FLOOR
PLAN

Sheet Number


A100

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PROJECTS/12500/12524U.2.00 TRI—CITY MEDICAL CENTER PARKING LOT\DWGS\SHEET_DWGS\12524U.2.00—TITL—DETL.DWG (09—26—17 1:55:15PM)
s.09.02 PM \regalDatalGeneral\TempDiegoLastres\TricityAntTCMC Parking Lot.nt

LEGEND
EXISTING IMPROVEMENTS

ITEM	<u>SYMBOL</u>
PROPERTY LINE/RIGHT OF WAY LINE	ROW or P/L
EXISTING CONTOUR EXISTING SPOT ELEVATION LIGHT POST CHAIN LINK FENCE	405.71 × LP
BUILDING FOOTPRINT	
IRRIGATION CONTROL VALVE	□ICV
SEWER MANHOLE	(S)
SEWER CLEAN OUT	
SEWER CLEAN OUT	○ CO
	o CO s —

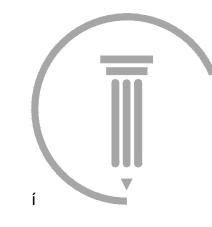

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<u>ITEM</u>	STANDARD DWG	<u>SYMBOL</u>
PERVIOUS CONCRETE PAVEMENT		
HYDROMODIFICATION MITIGATION & STORM WATER TREATMENT AREA		* * * * * * * *
ASPHALT PAVEMENT		
CONCRETE SIDEWALK		
6" CURB		
0" CURB		
LIGHTS (PER ELECTRICAL DWGS)		\(\text{\text{-}}\)
NEW STRIPING		
CONC. SWALE		4 4 4
CMU SCREEN.WALL		
TREE LIGHT (PER LANDSCAPE DWGS.)	⊹ ⊚
STORM DRAIN		SD
PERFORATED SUBDRAIN		— sp — — —
GRADED SWALE		\rightarrow \rightarrow \rightarrow \rightarrow \rightarrow
WING TYPE HEADWALL		
		٧

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Revisions No

ABBREVIATIONS

/ DDI IL V	// \
CL	CENTER LINE
CMU	CONC. MASONRY U
CO	CLEAN OUT
CONC.	CONCRETE
DWGS	DRAWINGS
ELEC	ELECTRIC
EX	EXISTING
GB	GRADE BREAK
PL	PROPERTY LINE
ROW	RIGHT-OF-WAY
TYP	TYPICAL

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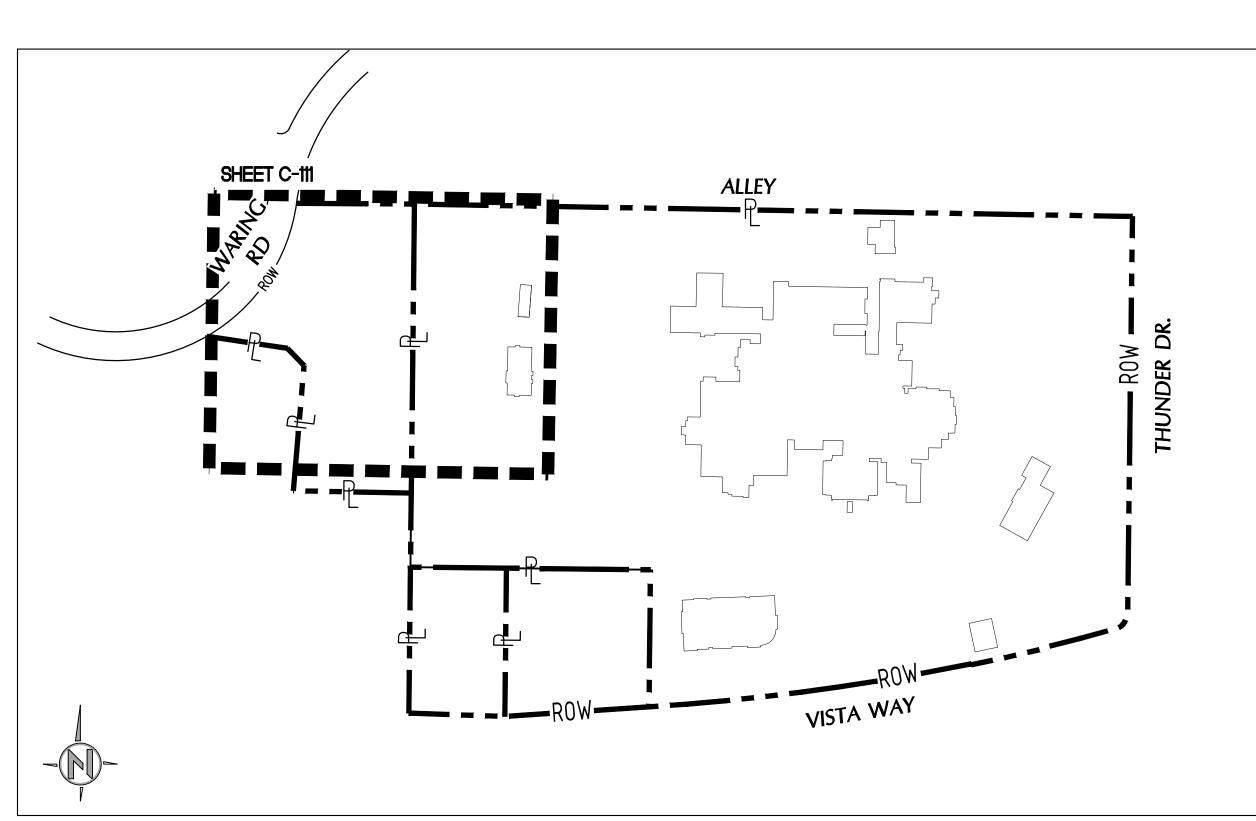
TCMC PARKING LOT


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CIVIL TITLE
SHEET

Sheet Number

C-001

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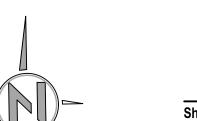
SCHEMATIC DESIGN Document Phase: SEPTEMBER 2017 Checked By:

TCMC PARKING LOT
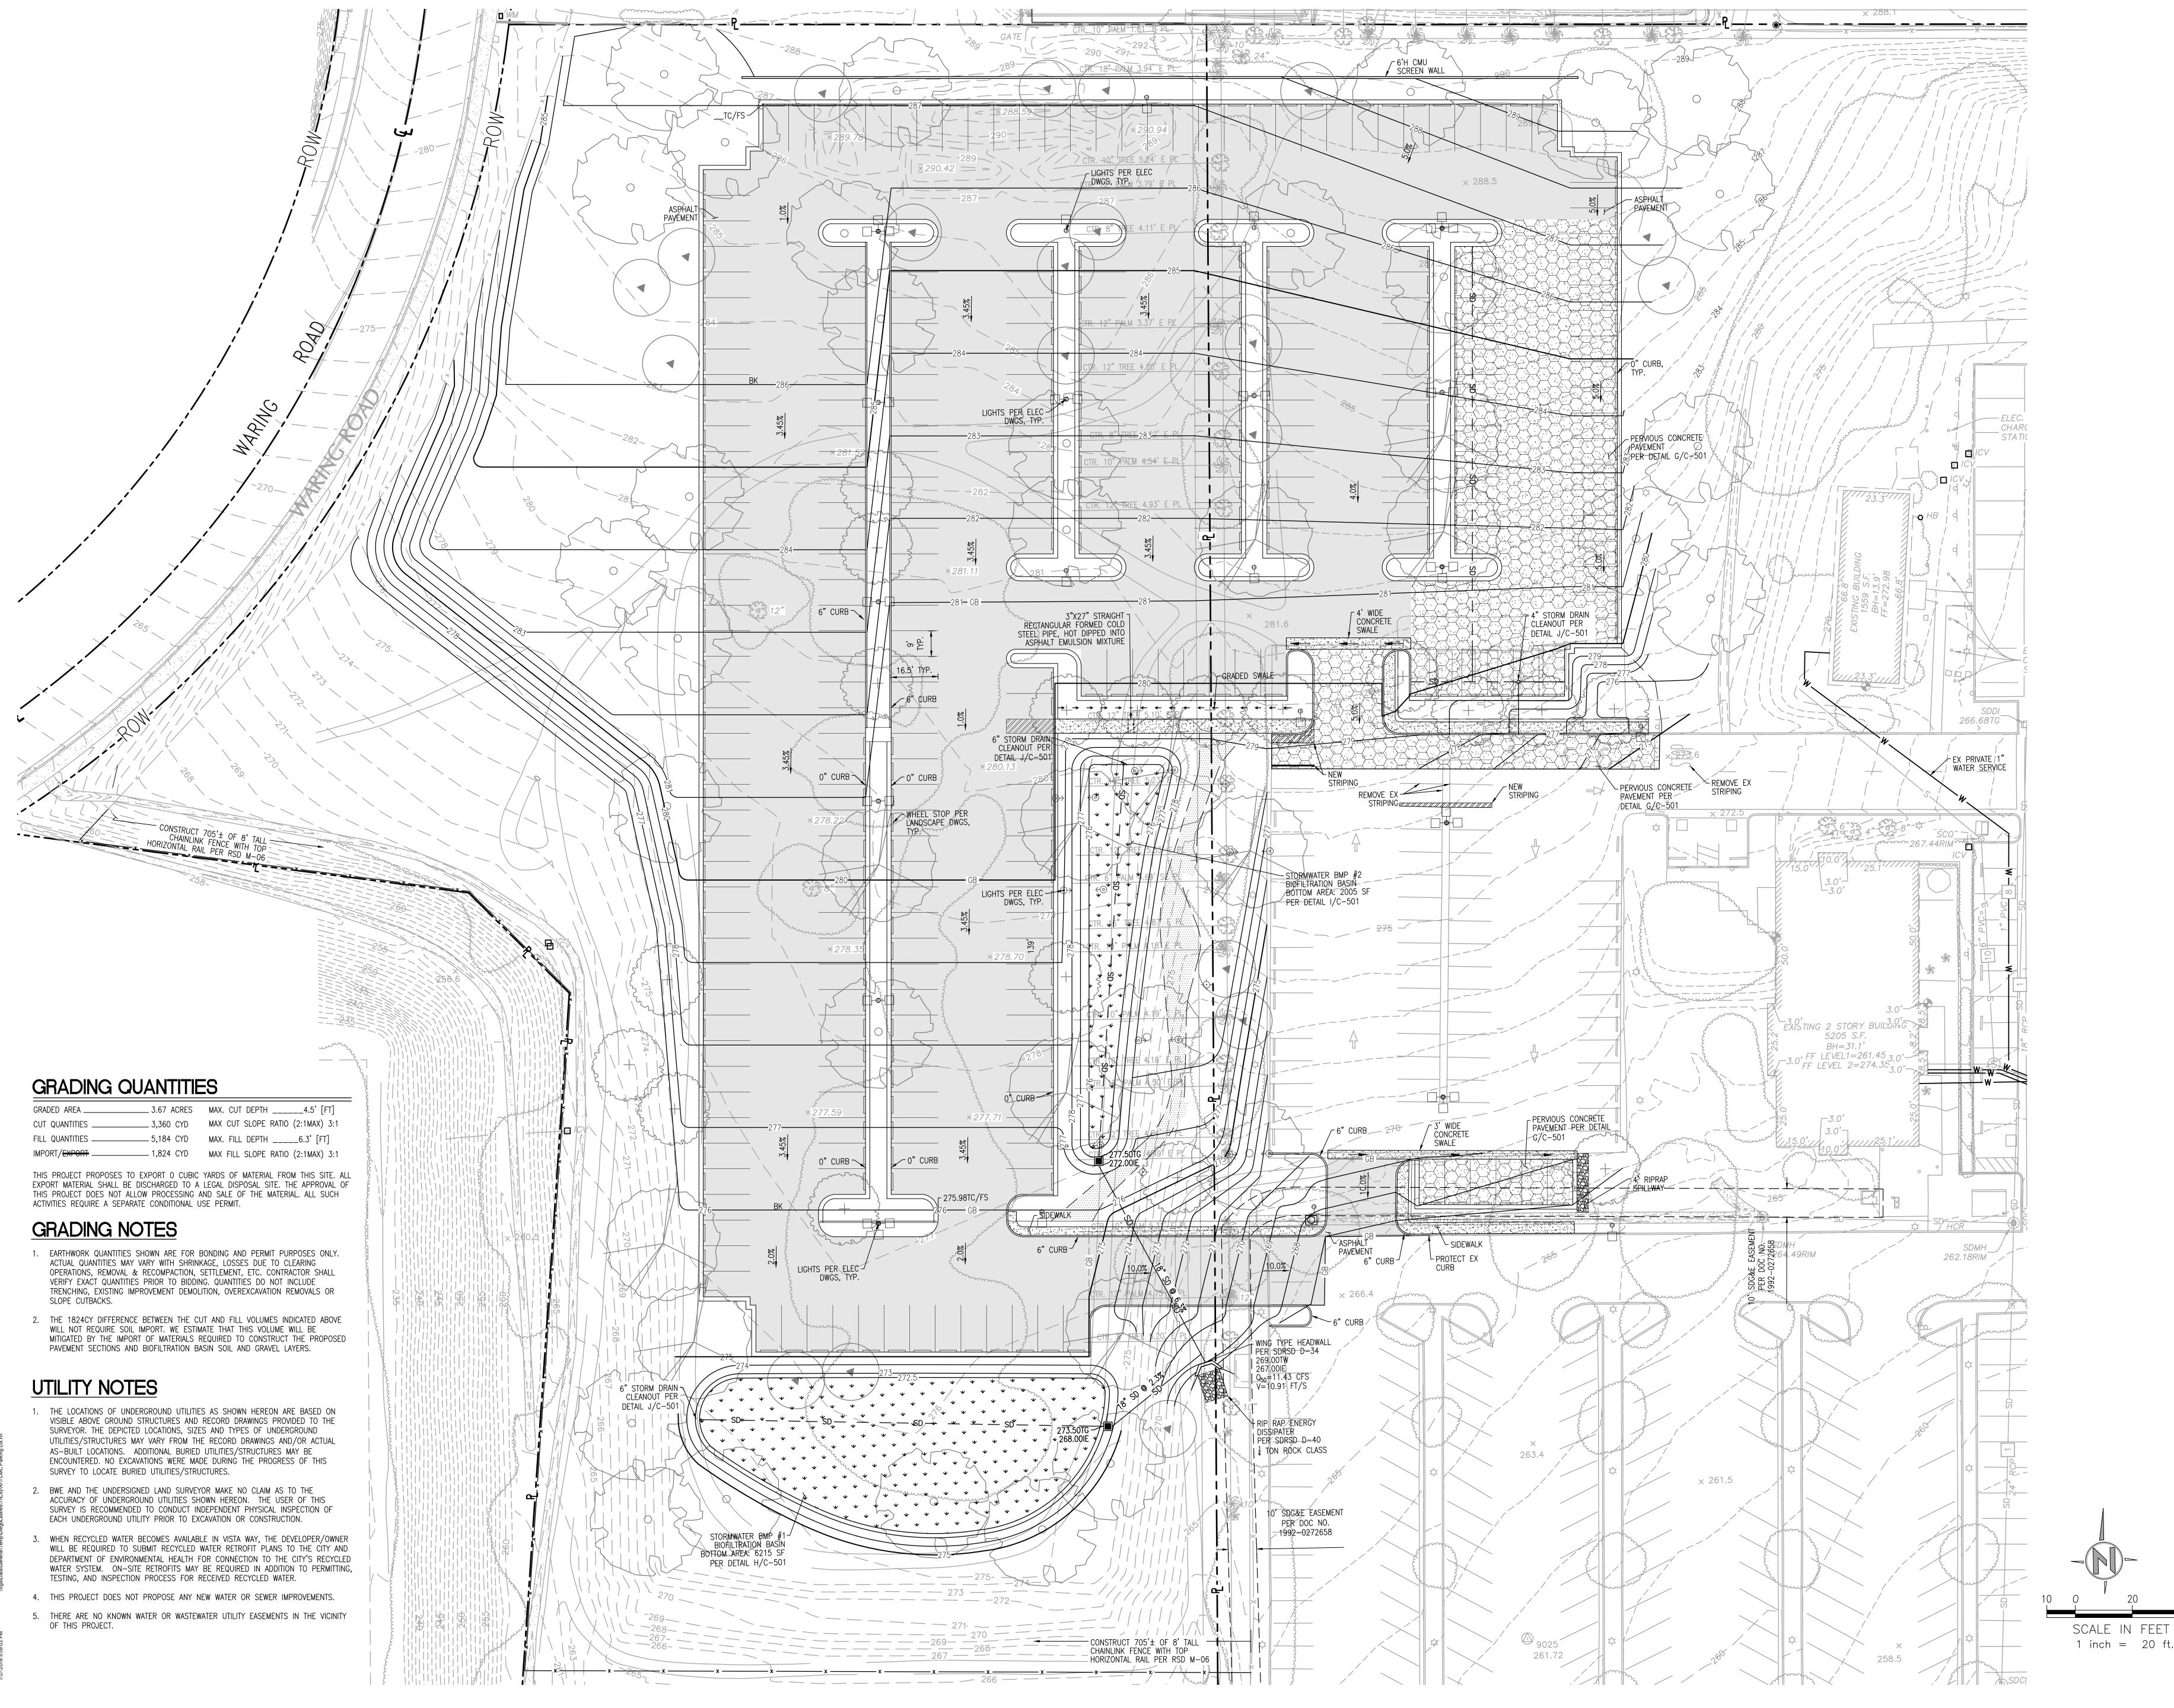
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GRADING PLAN




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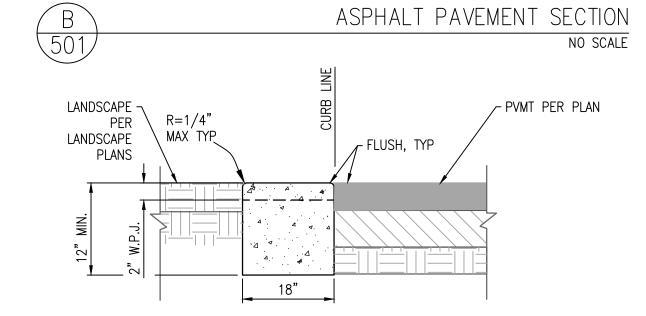
CONSTRUCT EXPANSION AND CONTROL JOINTS PER DETAIL D/C-501. 2. CONSTRUCT WEAKENED PLANE JOINTS AT MID POINT OF CURB RETURN, WHEN REQUIRED AND AT 15' INTERVALS FROM PCR'S ABSENT A CURB RAMP.

3. EXPANSION JOINTS AT CURB RETURNS, ADJACENT TO STRUCTURES AND AT 45' INTERVALS. 4. TOOL JOINTS $\frac{1}{4}$ " GROOVES WITH $\frac{1}{4}$ " RADIUS EDGES AT 5' INTERVALS 5. FOR DESIGNATED URBANIZED COMMUNITIES, SIDEWALK SCORING (GROOVES) PATTERN SHALL BE IN CONFORMANCE WITH HISTORIC DESIGN ON ADJACENT PROPERTIES.


CONCRETE WALKWAY PAVEMENT SECTION




. THIS AC PAVEMENT SECTION IS DESIGNED USING AN ASSUMED R-VALUE OF 10+ AND TRAFFIC INDEX OF 5. CONTRACTOR SHALL PERFORM R-VALUE TEST ON BULK SAMPLES OF THE SOILS THAT ARE EXPOSED AT THE FINISHED SUBGRADE ELEVATIONS ACROSS THE SITE ONCE GRADING OPERATIONS HAVE BEEN PERFORMED. R-VALUES THAT VARY FROM THE DESIGN VALUE MAY REQUIRE RE-DESIGN OF PAVEMENT SECTION. CONTRACTOR MAY MATCH EXISTING PAVEMENT SECTION IF APPROVED BY GEOTECHNICAL ENGINEER.

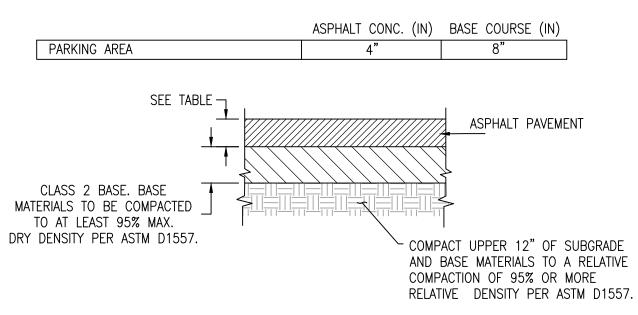

1. CONCRETE SHALL HAVE MINIMUM COMPRESSIVE STRENGTH OF 4,000 psi.

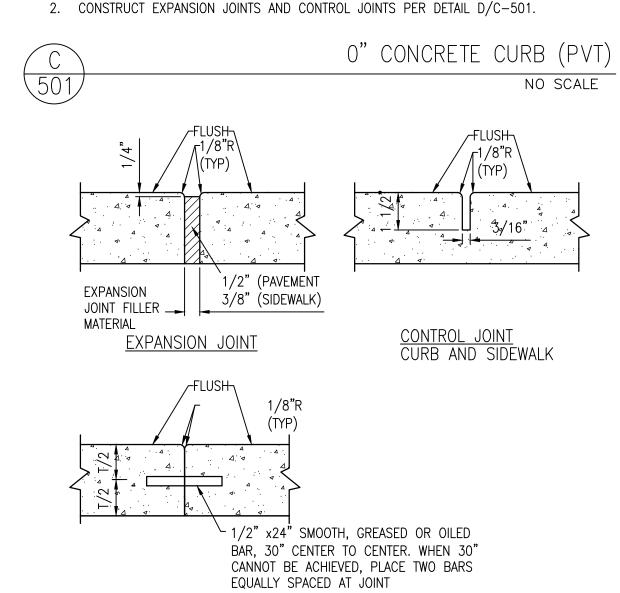

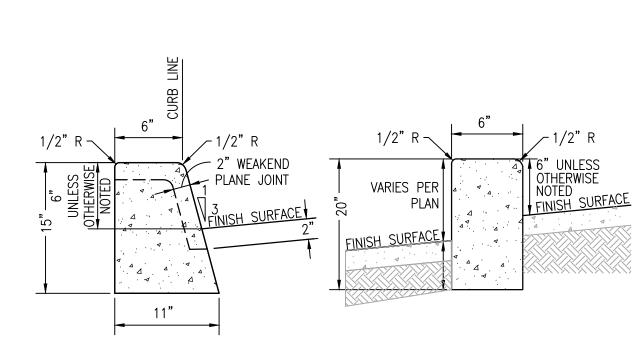

CONCRETE JOINTS DETAILS


NO SCALE


CONTACT JOINT


TYPE 1 CURB ADJACENT TO ROADWAYS TYPE 2 CURB AT WALKWAYS

NOTES:


1. CONCRETE SHALL HAVE MINIMUM COMPRESSIVE STRENGTH OF 3250 psi. 2. CONSTRUCT CONTROL JOINTS PER DETAIL D/C-501. 3. SLOPE TOP OF TYPE 1 CURB 1/4" PER FOOT TOWARD STREET.

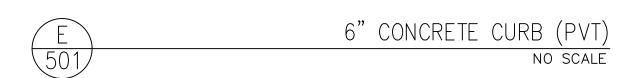


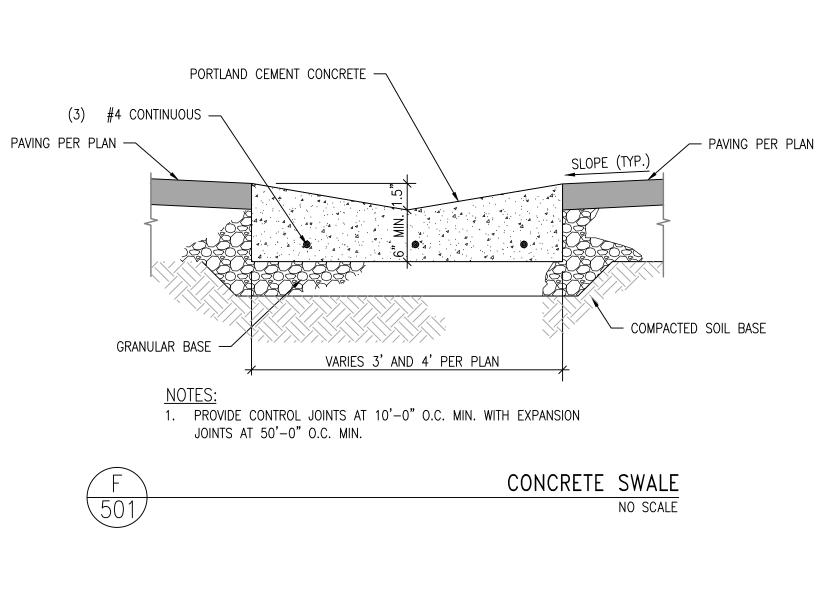

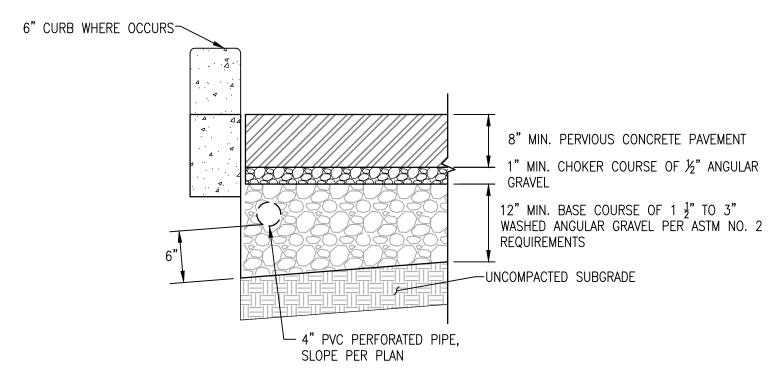

1. ALL STONE LAYERS MUST BE CLEAN AND FREE OF FINE GRANULAR MATERIAL PERVIOUS CONCRETE SHALL BE INSTALLED PER MANUFACTURER SPECIFICATIONS. 3. SECTION MAY VARY PER GEOTECHNICAL RECOMMENDATIONS

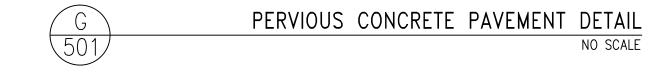


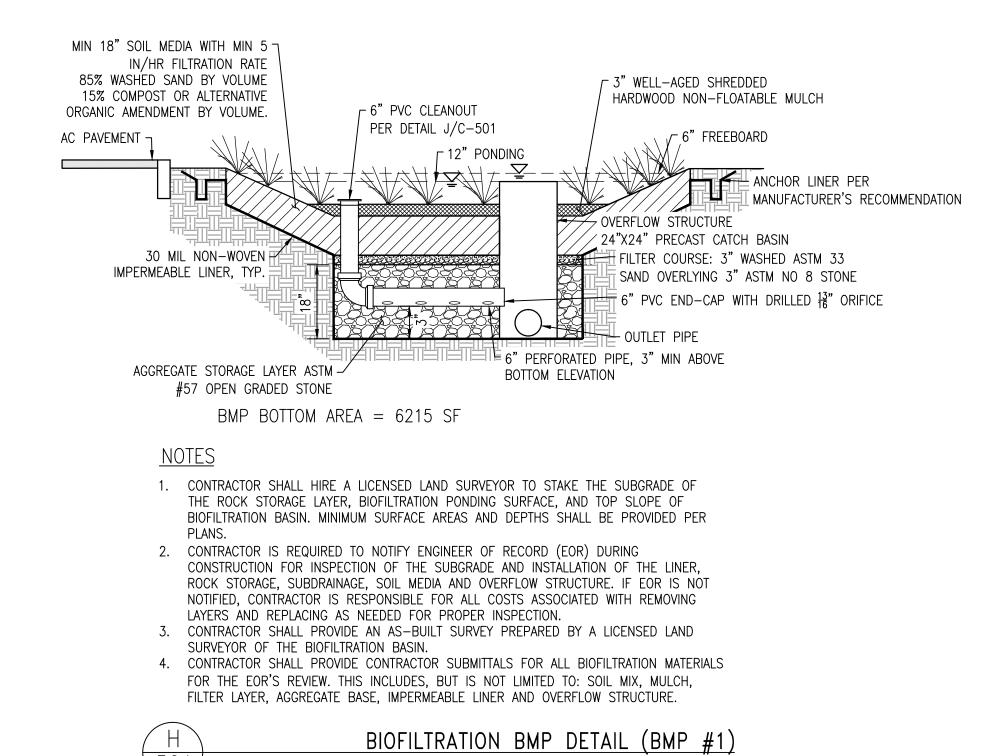

MIN 18" SOIL MEDIA WITH MIN 57 IN/HR FILTRATION RATE ┌ 3" WELL-AGED SHREDDED 85% WASHED SAND BY VOLUME HARDWOOD NON-FLOATABLE MULCH 15% COMPOST OR ALTERNATIVE ┌ 6" PVC CLEANOUT, ORGANIC AMENDMENT BY VOLUME. PER DETAIL J/C-501 AC PAVEMENT ¬ √ 6" FREEBOARD ANCHOR LINER PER
MANUFACTURER'S RECOMMENDATION OVERFLOW STRUCTURE / 24"X24" PRECAST CATCH BASIN 30 MIL NON-WOVEN FILTER COURSE: 3" WASHED ASTM 33 IMPERMEABLE LINER, TYP. SAND OVERLYING 3" ASTM NO 8 STONE 6" PVC END-CAP WITH DRILLED $\frac{13}{6}$ " ORIFICE 6" PERFORATED PIPE, 3" MIN ABOVE

AGGREGATE STORAGE LAYER ASTM — BOTTOM ELEVATION #57 OPEN GRADED STONE BMP BOTTOM AREA = 2005 SF

BIOFILTRATION BMP DETAIL (BMP #2)

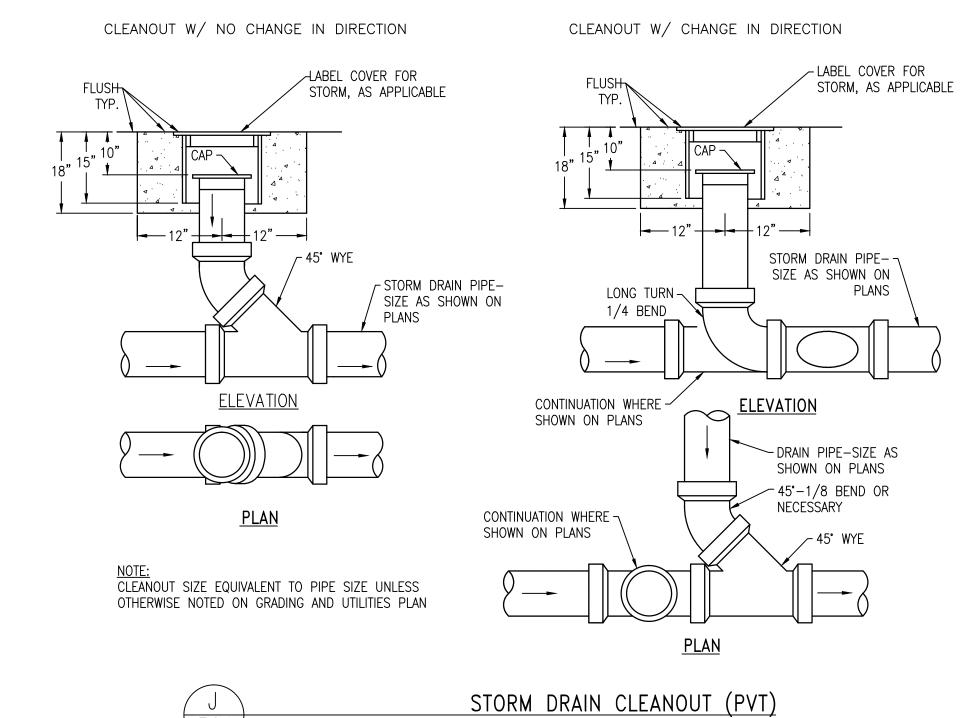

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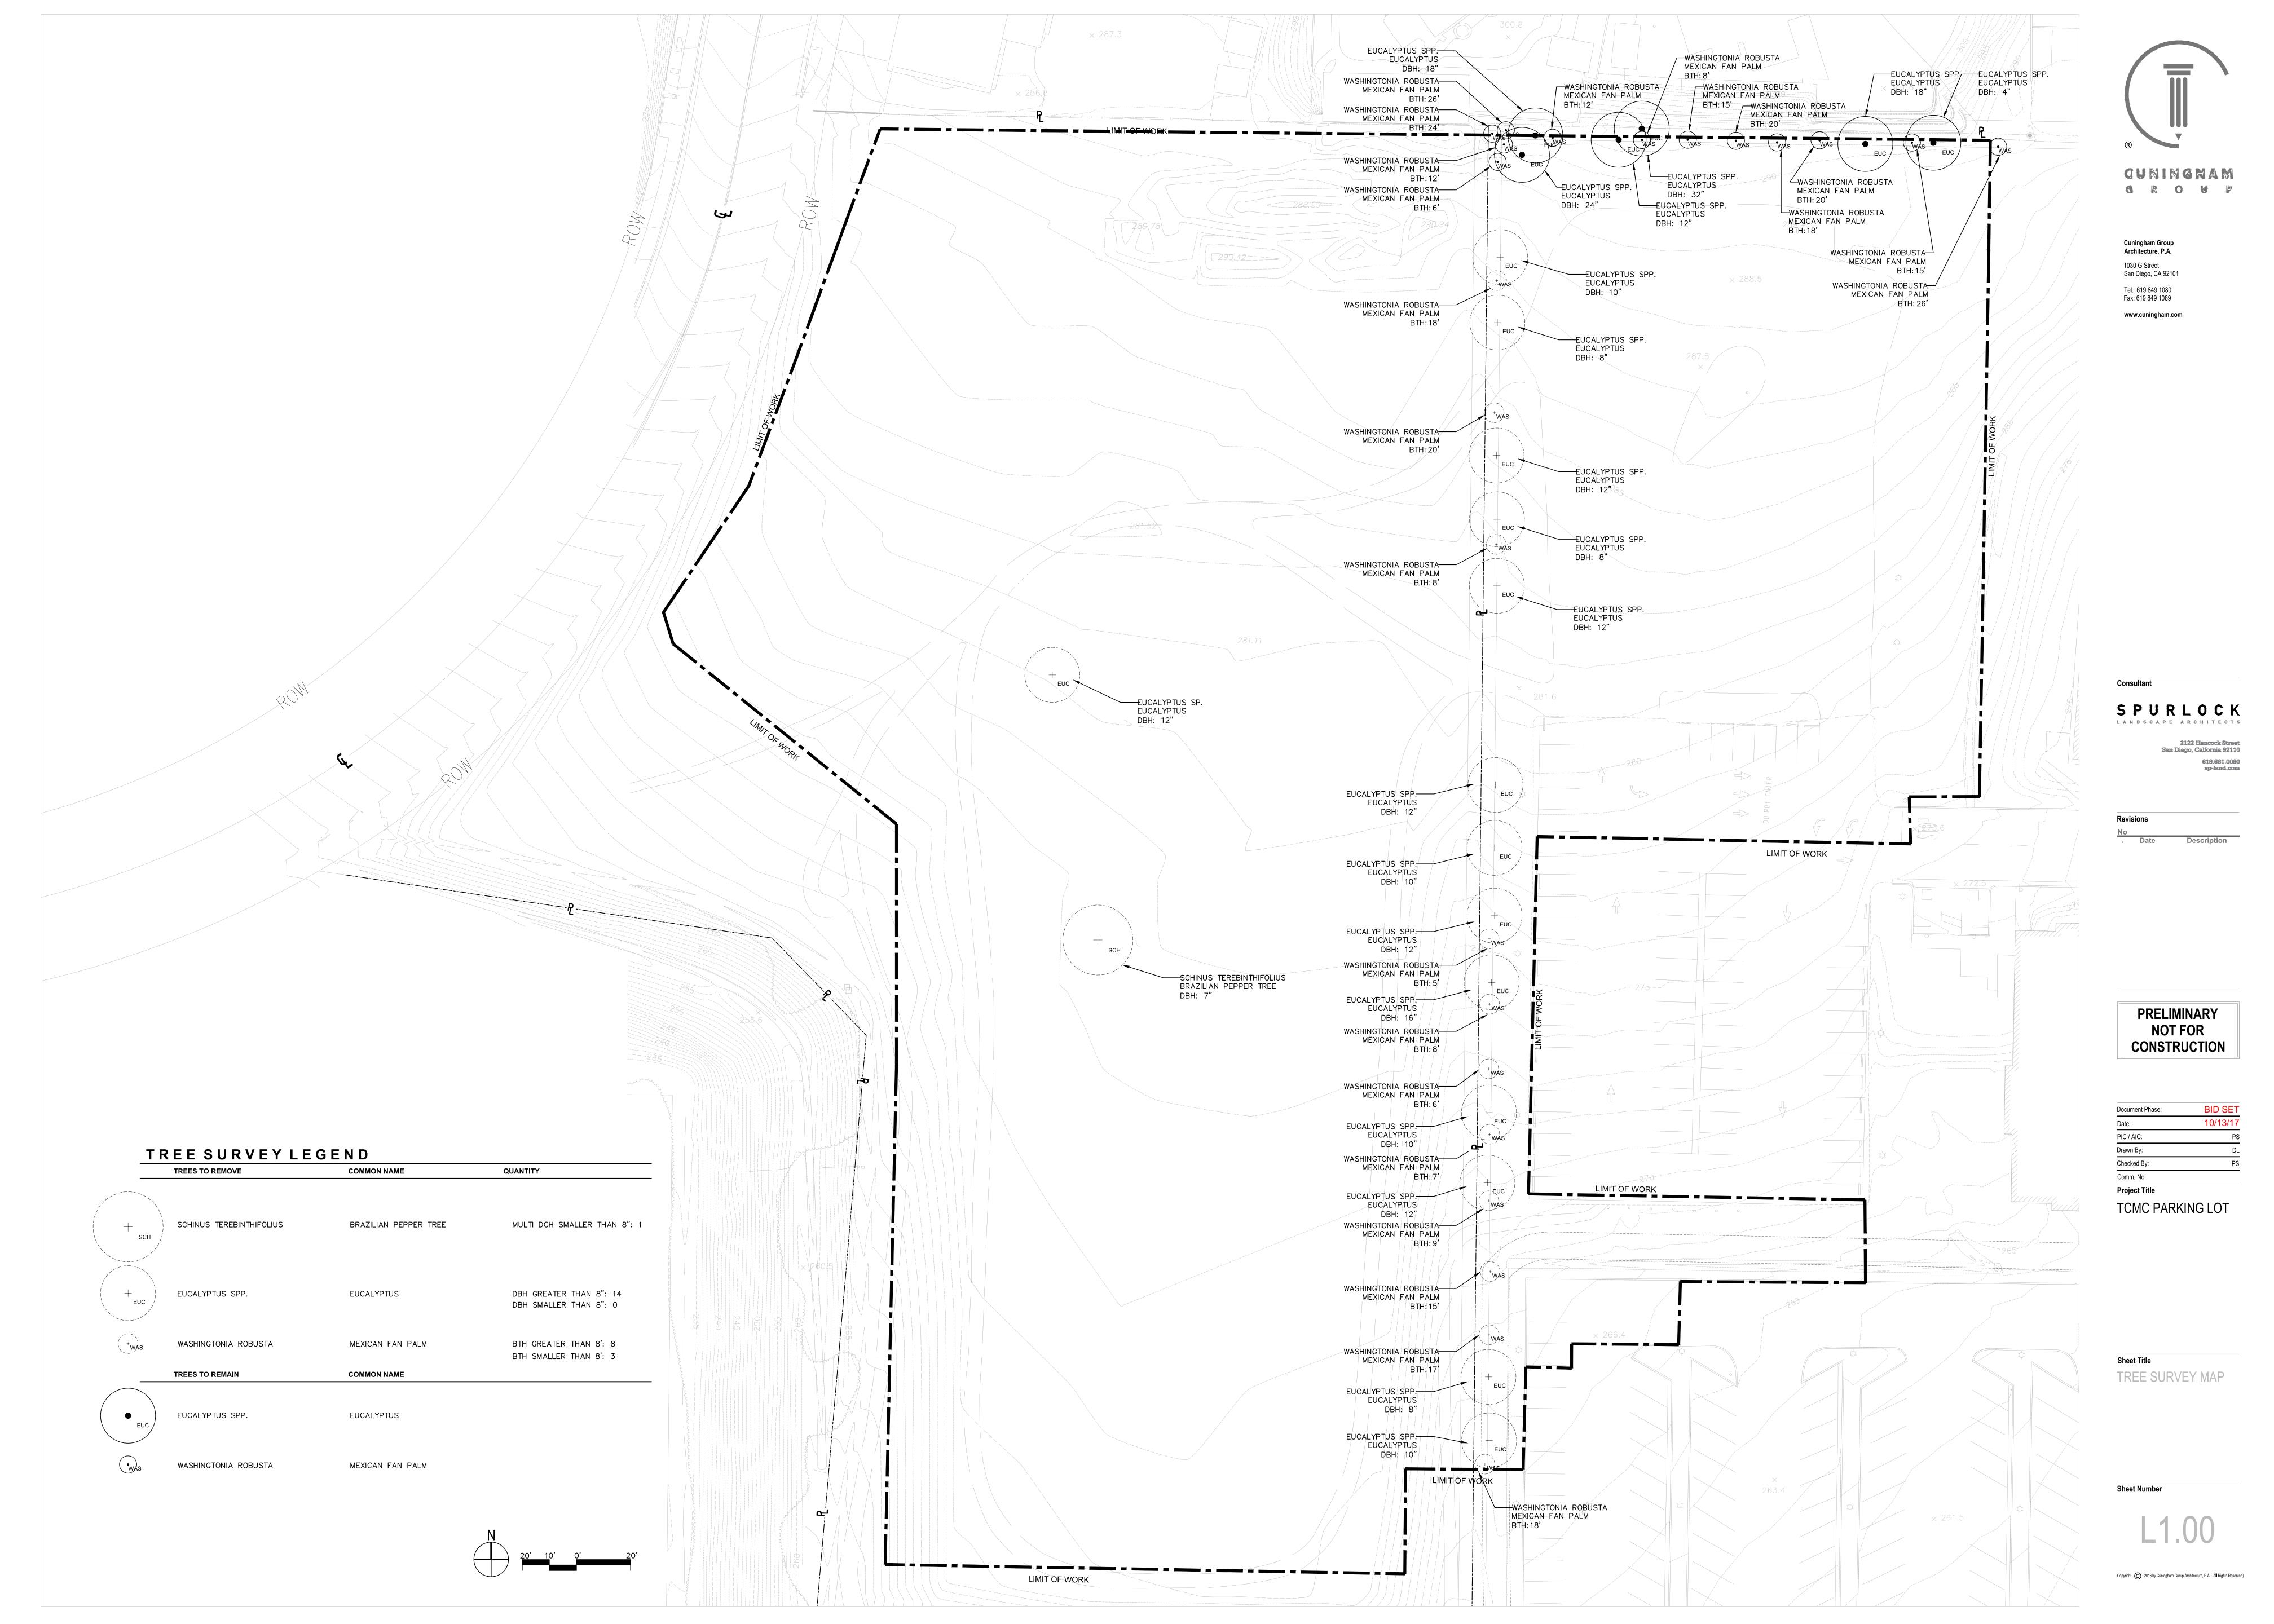
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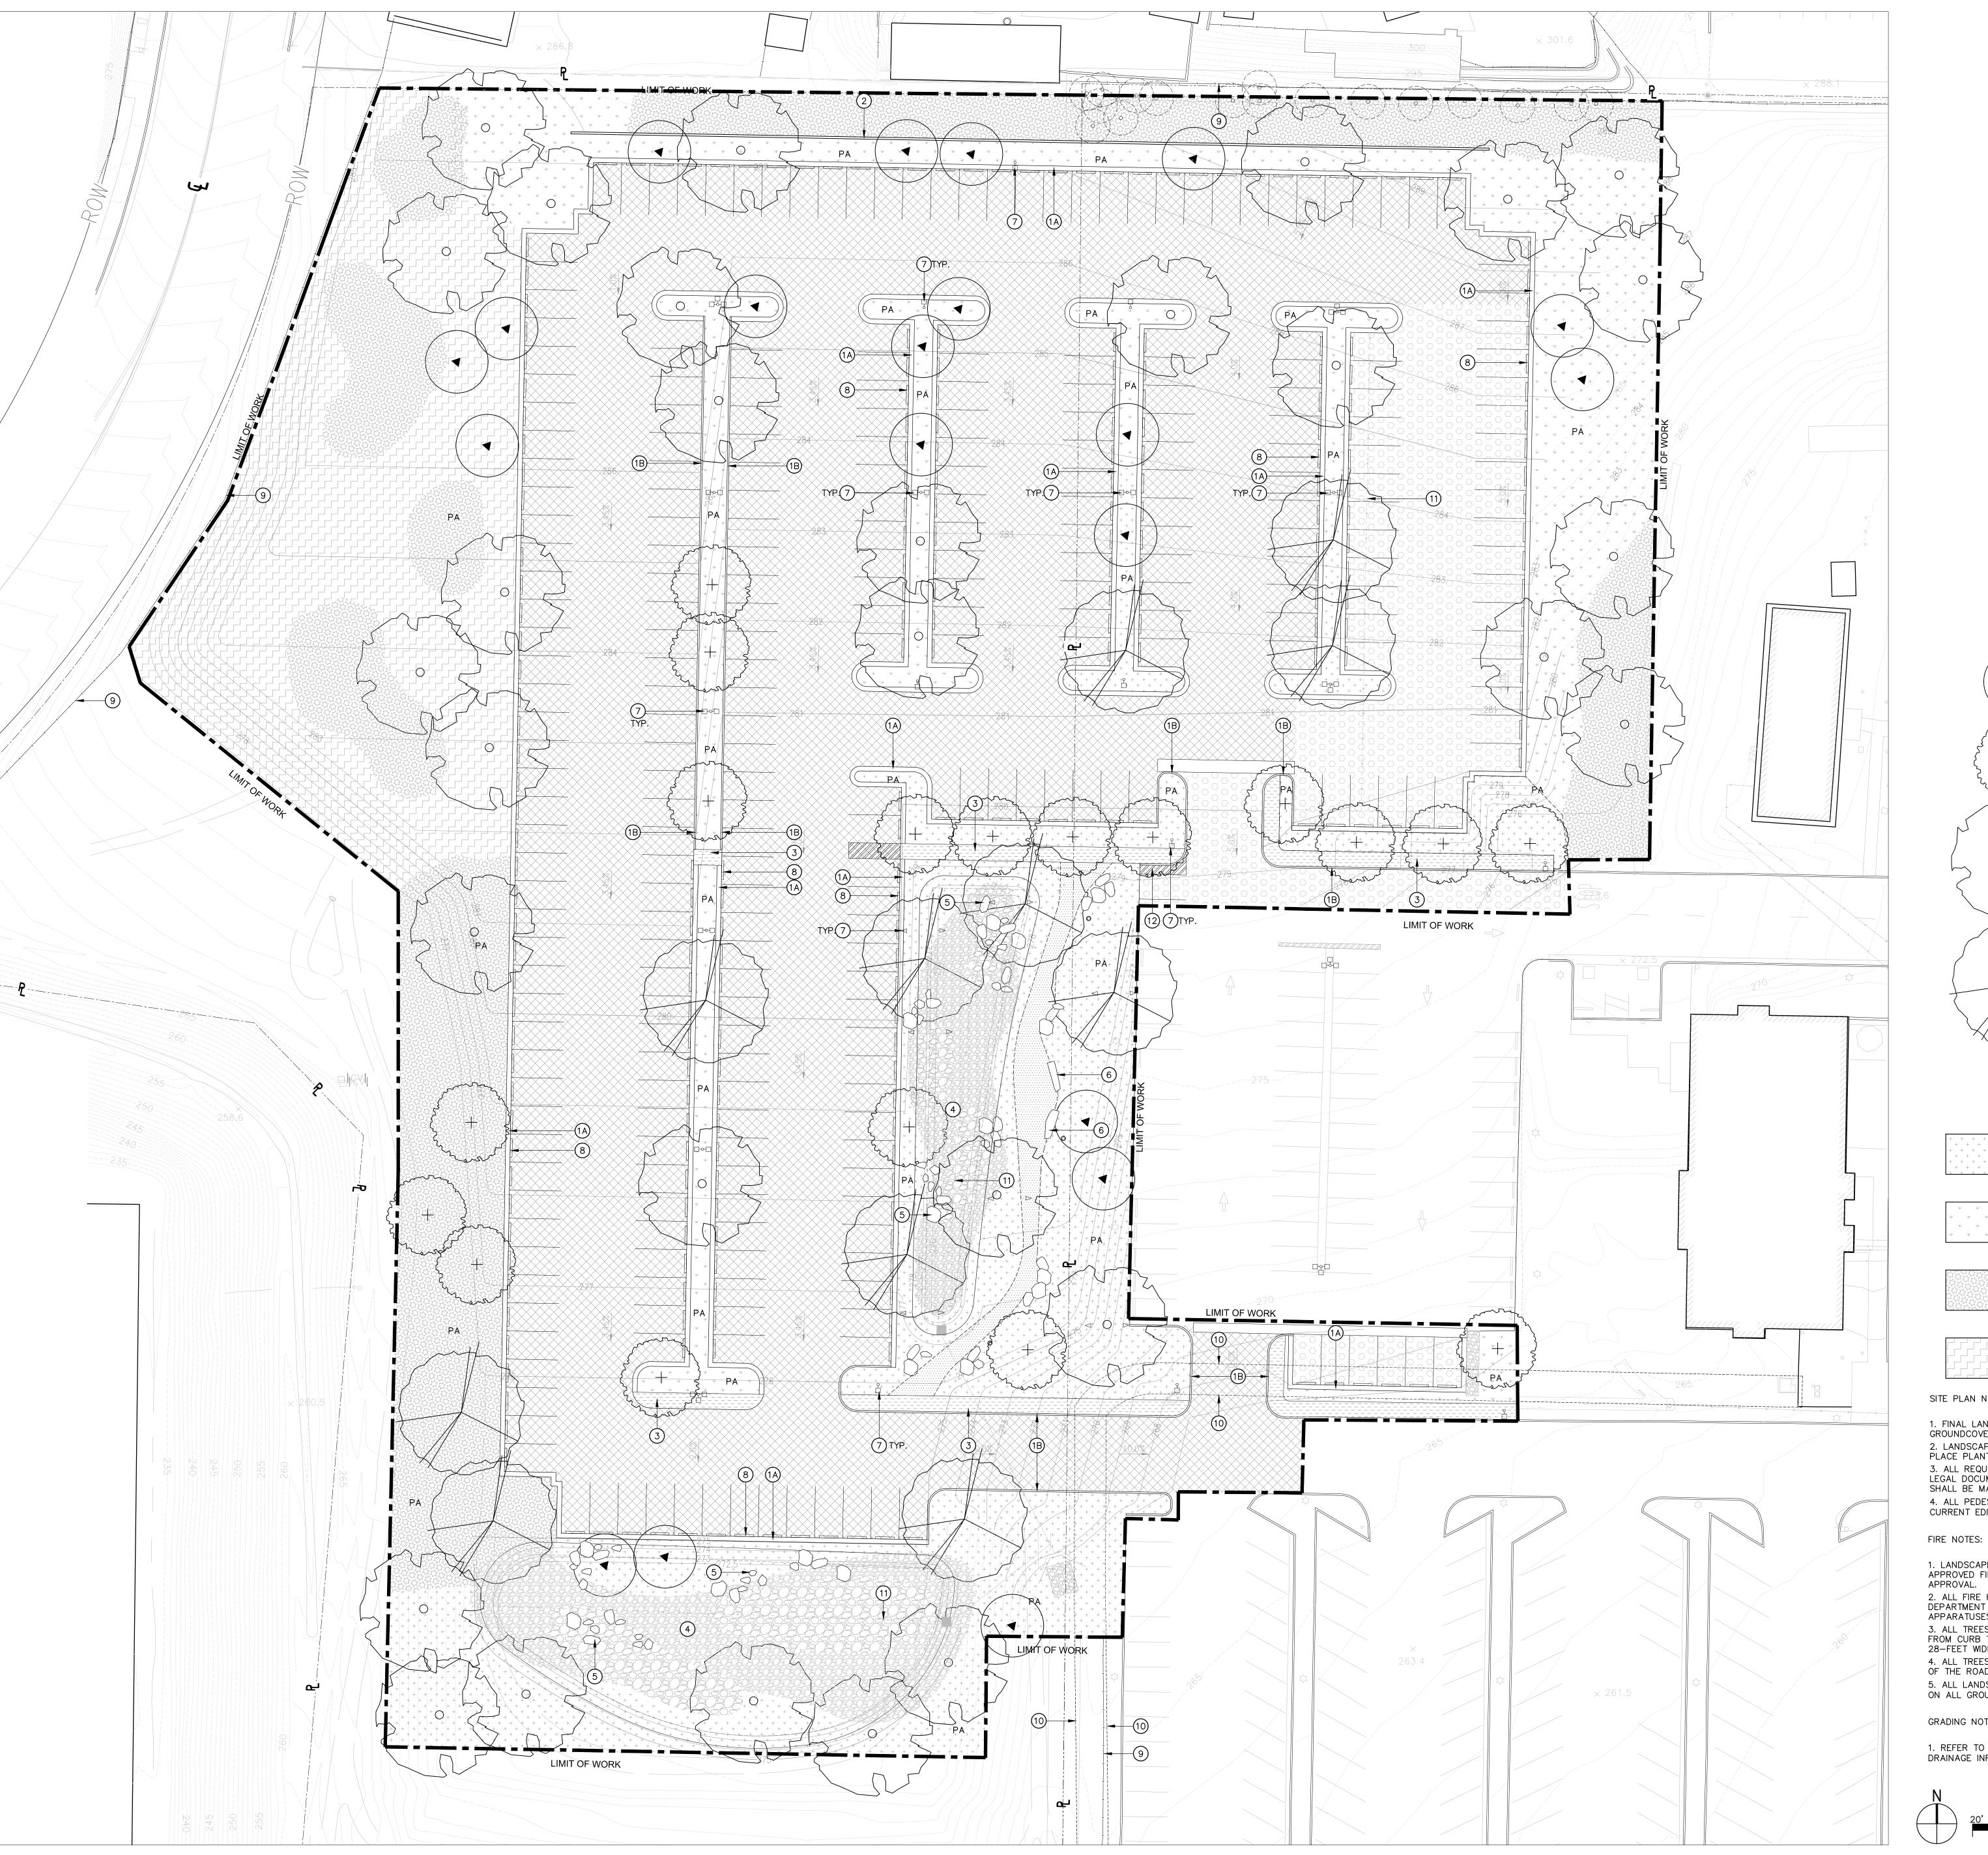
CIVIL DETAILS

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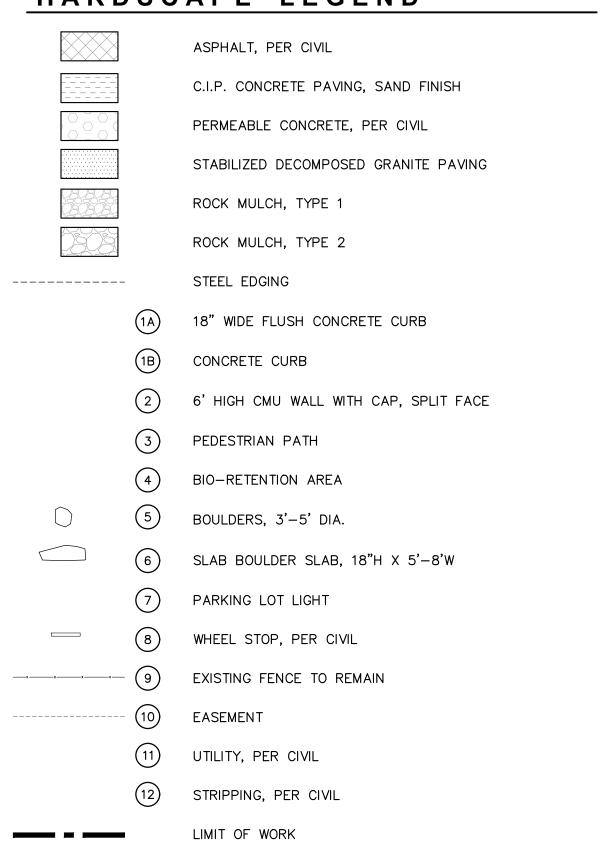
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HARDSCAPE LEGEND



PLANTING LEGEND


PROPERTY LINES

	TREES	COMMON NAME	
	ARBUTUS UNEDO	STRAWBERRY TREE	
+	PINUS CANARIENSIS	CANARY ISLAND PINE	Consultant
	QUERCUS ILEX	HOLLY OAK	S P U R L O C K L A N D S C A P E A R C H I T E C T S 2122 Hancock Street San Diego, Calfornia 92110 619.681.0090 sp-land.com
	TIPUANA TIPU	TIPU TREE	Revisions No Date Description
	EXISTING TREE TO REMAIN SHRUB AND GRASS		_

TALL SHRUB

PERIMETER PLANTING

GRASS MEADOW

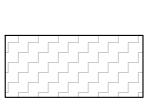

HYDROSEED

SITE PLAN NOTES:

1. FINAL LANDSCAPE PLANS SHALL ACCURATELY SHOW PLACEMENT OF TREES, SHRUBS, AND GROUNDCOVERS. 2. LANDSCAPE ARCHITECTS SHALL BE AWARE OF UTILITY, SEWER, STORM DRAIN EASEMENT AND PLACE PLANTING LOCATIONS ACCORDINGLY TO MEET CITY OF OCEANSIDE REQUIREMENTS. 3. ALL REQUIRED LANDSCAPE AREAS SHALL BE MAINTAINED BY OWNER OR AS STATED IN ANY LEGAL DOCUMENT SUCH AS BUT NOT LIMITED TO A LEASE AGREEMENT. THE LANDSCAPE AREAS SHALL BE MAINTAINED PER CITY OF OCEANSIDE REQUIREMENTS. 4. ALL PEDESTRIAN PAVING (BOTH DECORATIVE AND STANDARD) SHALL COMPLY WITH THE MOST CURRENT EDITION OF THE AMERICAN DISABILITY ACT.

1. LANDSCAPE IMPROVEMENT PLAN SET AND INSTALLATION ARE REQUIRED TO IMPLEMENT APPROVED FIRE DEPT. REGULATION, CODES, AND STANDARDS AT THE TIME OF PROJECT APPROVAL. 2. ALL FIRE HYDRANTS, DOUBLE CHECK DETECTORS, POST INDICATING VALVES, AND FIRE DEPARTMENT CONNECTIONS SHALL BE PROVIDED WITH A 3-FOOT CLEARANCE AROUND ALL FIRE 3. ALL TREES AT MATURITY SHALL MEET A HORIZONTAL CLEARANCE ALONG ALL ROADWAYS FROM CURB TO CURB. HORIZONTAL ROADWAY CLEARANCE FOR A ONE-STORY BUILDING IS

4. ALL TREES AT MATURITY SHALL MEET A VERTICAL CLEARANCE OF 14-FEET FROM THE TOP OF THE ROADWAY TO THE LOWEST BRANCHES. 5. ALL LANDSCAPING WILL MAINTAIN A 7' CANOPY ON ALL TREES AND A 3' MAXIMUM HEIGHT ON ALL GROUND COVER

GRADING NOTES:

1. REFER TO CIVIL'S PRELIMINARY GRADING AND DEVELOPMENT PLAN FOR GRADES AND DRAINAGE INFORMATION

TCMC PARKING LOT

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SITE PLAN

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	PLANTING L	EGEND	
	TREES	COMMON NAME	CONTAINER SIZE
	ARBUTUS UNEDO	STRAWBERRY TREE	36" BOX
+	PINUS CANARIENSIS	CANARY ISLAND PINE	48" BOX
	QUERCUS ILEX	HOLLY OAK	36" BOX
	TIPUANA TIPU	TIPU TREE	24" BOX
	EXISTING TREE TO REMAIN		

SHRUB AND GRASS	COMMON NAME	CONTAINER SIZE AND QUANTITY
GRASS MEADOW, SUCH AS	90% 1 GALLON AT 30" O.C./ 10% 5	5 GALLON AT 36" O.C. (20.600 SF)
MUHLENBERGIA RIGENS	DEER GRASS	1 GAL: 3430
CAREX TUMULICOLA	FOOTHILL SEDGE	5 GAL: 264
FESTUCA MAIREI	ATLAS FESCUE	
SESLERIA AUTUMNALIS	AUTUMN MOOR GRASS	
LEYMUS CONDENSATUS	GIANT WILD RYE	

PERIMETER PLANTING, SUCH AS 80% 1 GALLON AT 30" O.C. / 20% 5 GALLON AT 48" O.C. (16,500 SF)

1 GAL: 2442 5 GAL: 239 BACCHARIS PILULARIS 'PIGEON POINT' ARTEMISIA CALIFORNICA 'CANYON GRAY' COASTAL SAGEBRUSH ARTEMISIA 'POWIS CASTLE' WORMWOOD COTONEASTER GLAUCOPHYLLUS BOXWOOD COTONEASTER AGAVE AGAVE SP. SALVIA SP. SALVIA VIGUIERA LACINIATA SAN DIEGO SUNFLOWER

80% 5 GALLON AT 48" O.C./ 20% 15 GALLON AT 72" O.C. (21,000 SF) TALL SHRUB, SUCH AS

ARTEMISIA TRIDENTATA	SAGFBRUSH	5 GAL: 1218
CEANOTHUS SP.	CALIFORNIA LILAC	15 GAL: 134
COTONEASTER LACTEUS	RED CLUSTERBERRY	
HETEROMELES ARBUTIFOLIA 'DAVIS GOLD'	DAVIS GOLD TOYON	
RHUS INTEGRIFOLIA	LEMONADE BERRY	
RHAMNUS CALIFORNICA 'LEATHERLEAF'	COFFEEBERRY	
RHAPHIOLEPIS UMBELLATA	INDIAN HAWTHORN	
PITTOSPORUM CRASSIFOLIUM	KARO	
PITTOSPORUM TOBIRA	MOCK ORANGE	

HYDROSEED (14,400 SF) ACHILLEA MILLEFOLIUM YARROW BOUTELOUA GRACILIS BLUE GRAMMA GRASS BUCHLOE DACTYLOIDES BUFFALO GRASS DESCHAMPSIA CESPITOSA TUFTED HAIRGRASS GAZANIA SPLENDENS GAZANIA FESTUCA RUBRA RED FESCUE KOELERIA MACRANTHA JUNE GRASS MELICA IMPERFECTA COAST RANGE MELIC MUHLENBERGIA RIGENS DEERGRASS SCARLET BUGLER PENSTEMON CENTRANTHIFOLIUS BACCHARIS PILULARIS DWARF COYOTE BRUSH CEANOTHUS VERRUCOSUS COAST WHITE LILAC ACHILLEA MILLEFOLIUM YARROW LINUM LEWISII BLUE FLAX LUPINUS NANUS 'PIXIE DELIGHT' SKY LUPINE LUPINUS TRUNCATUS COLLAR LUPINE

BABY BLUE EYES

CALIFORNIA BLUEBELLS

FUSCHIA, MOSS VERBENA


BLUE EYED GRASS

NEMOPHILIA MENZIESII

SISYRINCHIUM BELLUM

VERBENA TENUISECTA

PHACELIA CAMPAXIULARIA

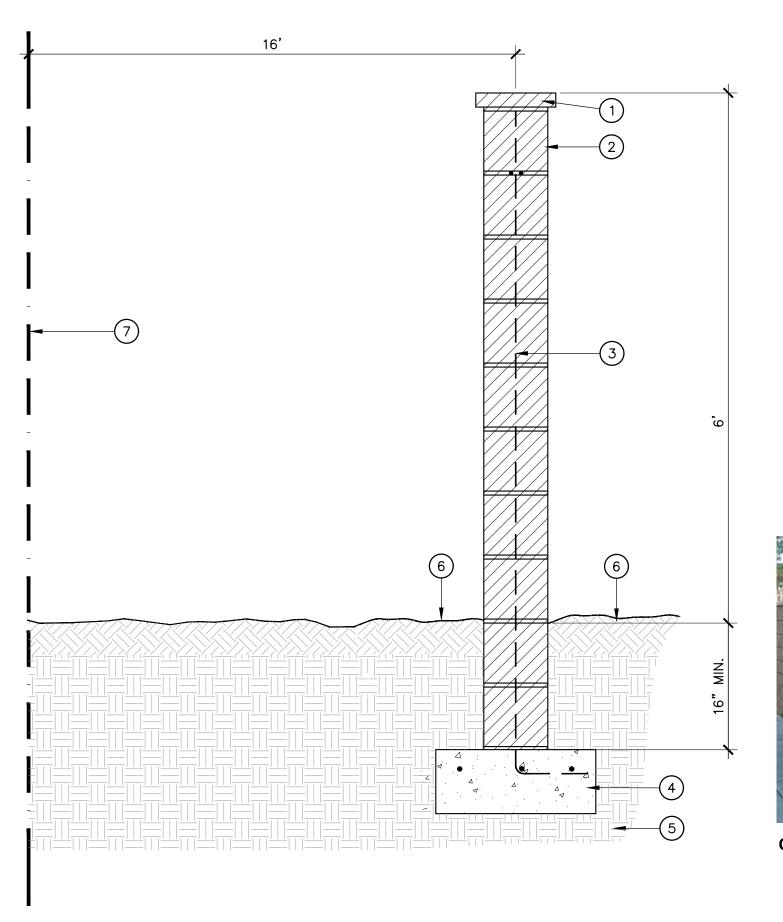

1) 2x10x16 CMU WALL CAP 2 8X8X16 CMU BLOCK WALL WITH SPLIT FACE FACING PARKING LOT SIDE REINFORCING CONCRETE FOOTING COMPACTED SUBGRADE 6 FINISH GRADE 7 PROPERTY LINE

CHARACTER IMAGE

SECTION SCALE 1"= 1'-0"

6' HIGH SCREEN WALL

IRRIGATION NOTES:

1. AN AUTOMATIC IRRIGATION SYSTEM SHALL BE INSTALLED TO PROVIDE COVERAGE FOR ALL PLANTING AREAS SHOWN ON THE PLAN. LOW VOLUME EQUIPMENT SHALL PROVIDE SUFFICIENT WATER FOR PLANT GROWTH WITH A MINIMUM WATER LOSS DUE TO WATER RUN-OFF. IRRIGATION SYSTEMS SHALL USE HIGH QUALITY, AUTOMATIC CONTROL VALVES, CONTROLLERS AND OTHER NECESSARY IRRIGATION EQUIPMENT. ALL COMPONENTS SHALL BE OF NON-CORROSIVE MATERIAL. ALL DRIP SYSTEMS SHALL BE ADEQUATELY FILTERED AND REGULATED PER THE MANUFACTURER'S RECOMMENDED DESIGN PARAMETERS. ALL IRRIGATION IMPROVEMENTS SHALL FOLLOW THE CITY OF OCEANSIDE GUIDELINES AND WATER CONSERVATION ORDINANCE.

PLANTING NOTES:

1. THE SELECTION OF PLANT MATERIAL IS BASED ON CULTURAL, AESTHETIC, AND MAINTENANCE CONSIDERATIONS. ALL PLANTING AREAS SHALL BE PREPARED WITH APPROPRIATE SOIL AMENDMENTS, FERTILIZERS, AND APPROPRIATE SUPPLEMENTS BASED UPON A SOILS REPORT FROM AN AGRICULTURAL SUITABILITY SOIL SAMPLE TAKEN FROM THE SITE. GROUND COVERS OR BARK MULCH SHALL FILL IN BETWEEN THE SHRUBS TO SHIELD THE SOIL FROM THE SUN, EVAPOTRANSPIRATION AND RUN-OFF. ALL THE FLOWER AND SHRUB BEDS SHALL BE MULCHED TO A 3" DEPTH TO HELP CONSERVE WATER, LOWER THE SOIL TEMPERATURE AND REDUCE WEED GROWTH. THE SHRUBS SHALL BE ALLOWED TO GROW IN THEIR NATURAL FORMS. ALL LANDSCAPE IMPROVEMENTS SHALL FOLLOW THE CITY OF OCEANSIDE GUIDELINES.

- STREET TREES AND OTHER TREES SHALL BE SPACED:
- A. 8 FEET (PREVIOUSLY 3 FEET) FROM TRANSFORMERS, CABLE, AND PULL BOXES. B. 5 FEET FROM MAILBOXES
- C. 5 FEET FROM FIRE HYDRANTS (ALL SIDES)
- D. 10 FEET FROM CENTERLINE (PREVIOUSLY 7 FEET) OF ALL UTILITY LINES (WITHOUT EASEMENT) (SEWER, WATER, STORM DRAINS, DOUBLE CHECK DETECTORS, AIR RELIEF VALVES AND GAS)
 - E. 10 FEET FROM EASEMENT BOUNDARIES (SEWER, WATER, STORM DRAINS, ACCESS OR OTHER UTILITIES) F. 10 FEET FROM DRIVEWAYS (UNLESS A LINE OF SIGHT IS DETERMINED BY THE TRAFFIC DIVISION TO BE OTHERWISE)
 - G. 10 FEET FROM TRAFFIC AND DIRECTIONAL SIGNS
 - H. 15 FEET (MINIMUM) FROM STREETLIGHTS, OTHER UTILITY POLES, (DETERMINED BY SPECIFICATIONS)
- I. STREET TREES SHALL BE PLANTED 3' OUTSIDE RIGHT-OF-WAY IF THE RIGHT-OF-WAY DOES NOT ALLOW SPACE, SUBJECT TO THE CITY ENGINEER'S APPROVAL
- J. LINE OF SIGHT AT ARTERIALS, COLLECTOR AND LOCAL STREETS SHALL BE REVIEWED AND DETERMINED BY TRAFFIC ENGINNER. A MINIMUM OF TWENTY-FIVE FEET (25') FROM STREET INTERSECTION OR AS APPROVED BY THE TRAFFIC ENGINNER
 - K. MINIMUM FIFTEEN FEET (15') STREETLIGHT AND STOP SIGN OR CLEARANCE DETERMINED BY SPECIFICATIONS
- L. SCREEN ALL UTILITIES ACCORDING TO SPECIFIC AGENCY REQUIREMENTS.

3. ALL STREET TREES SHALL COMPLY WITH THE CITY OF OCEANSIDE APPROVED STREET TREES AND STANDARD DETAIL 211A. 4. ROOT BARRIER SHALL BE INSTALLED ADJACENT TO ALL PAVING SURFACES WHERE A PAVING SURFACE IS LOCATED WITHIN 6 FEET OF A TREE TRUNK ON SITE (PRIVATE) AND WITHIN 10 FEET OF A TREE TRUNK IN THE RIGHT-OF-WAY (PUBLIC). ROOT BARRIERS SHALL EXTEND 5 FEET IN EACH DIRECTION FROM THE CENTERLINE OF THE TRUNK, FOR A TOTAL DISTANCE OF 10 FEET. ROOT BARRIER SHALL BE 24 INCHES IN DEPTH. INSTALLING A ROOT BARRIER AROUND THE TREE'S ROOT BALL IS UNACCEPTABLE.



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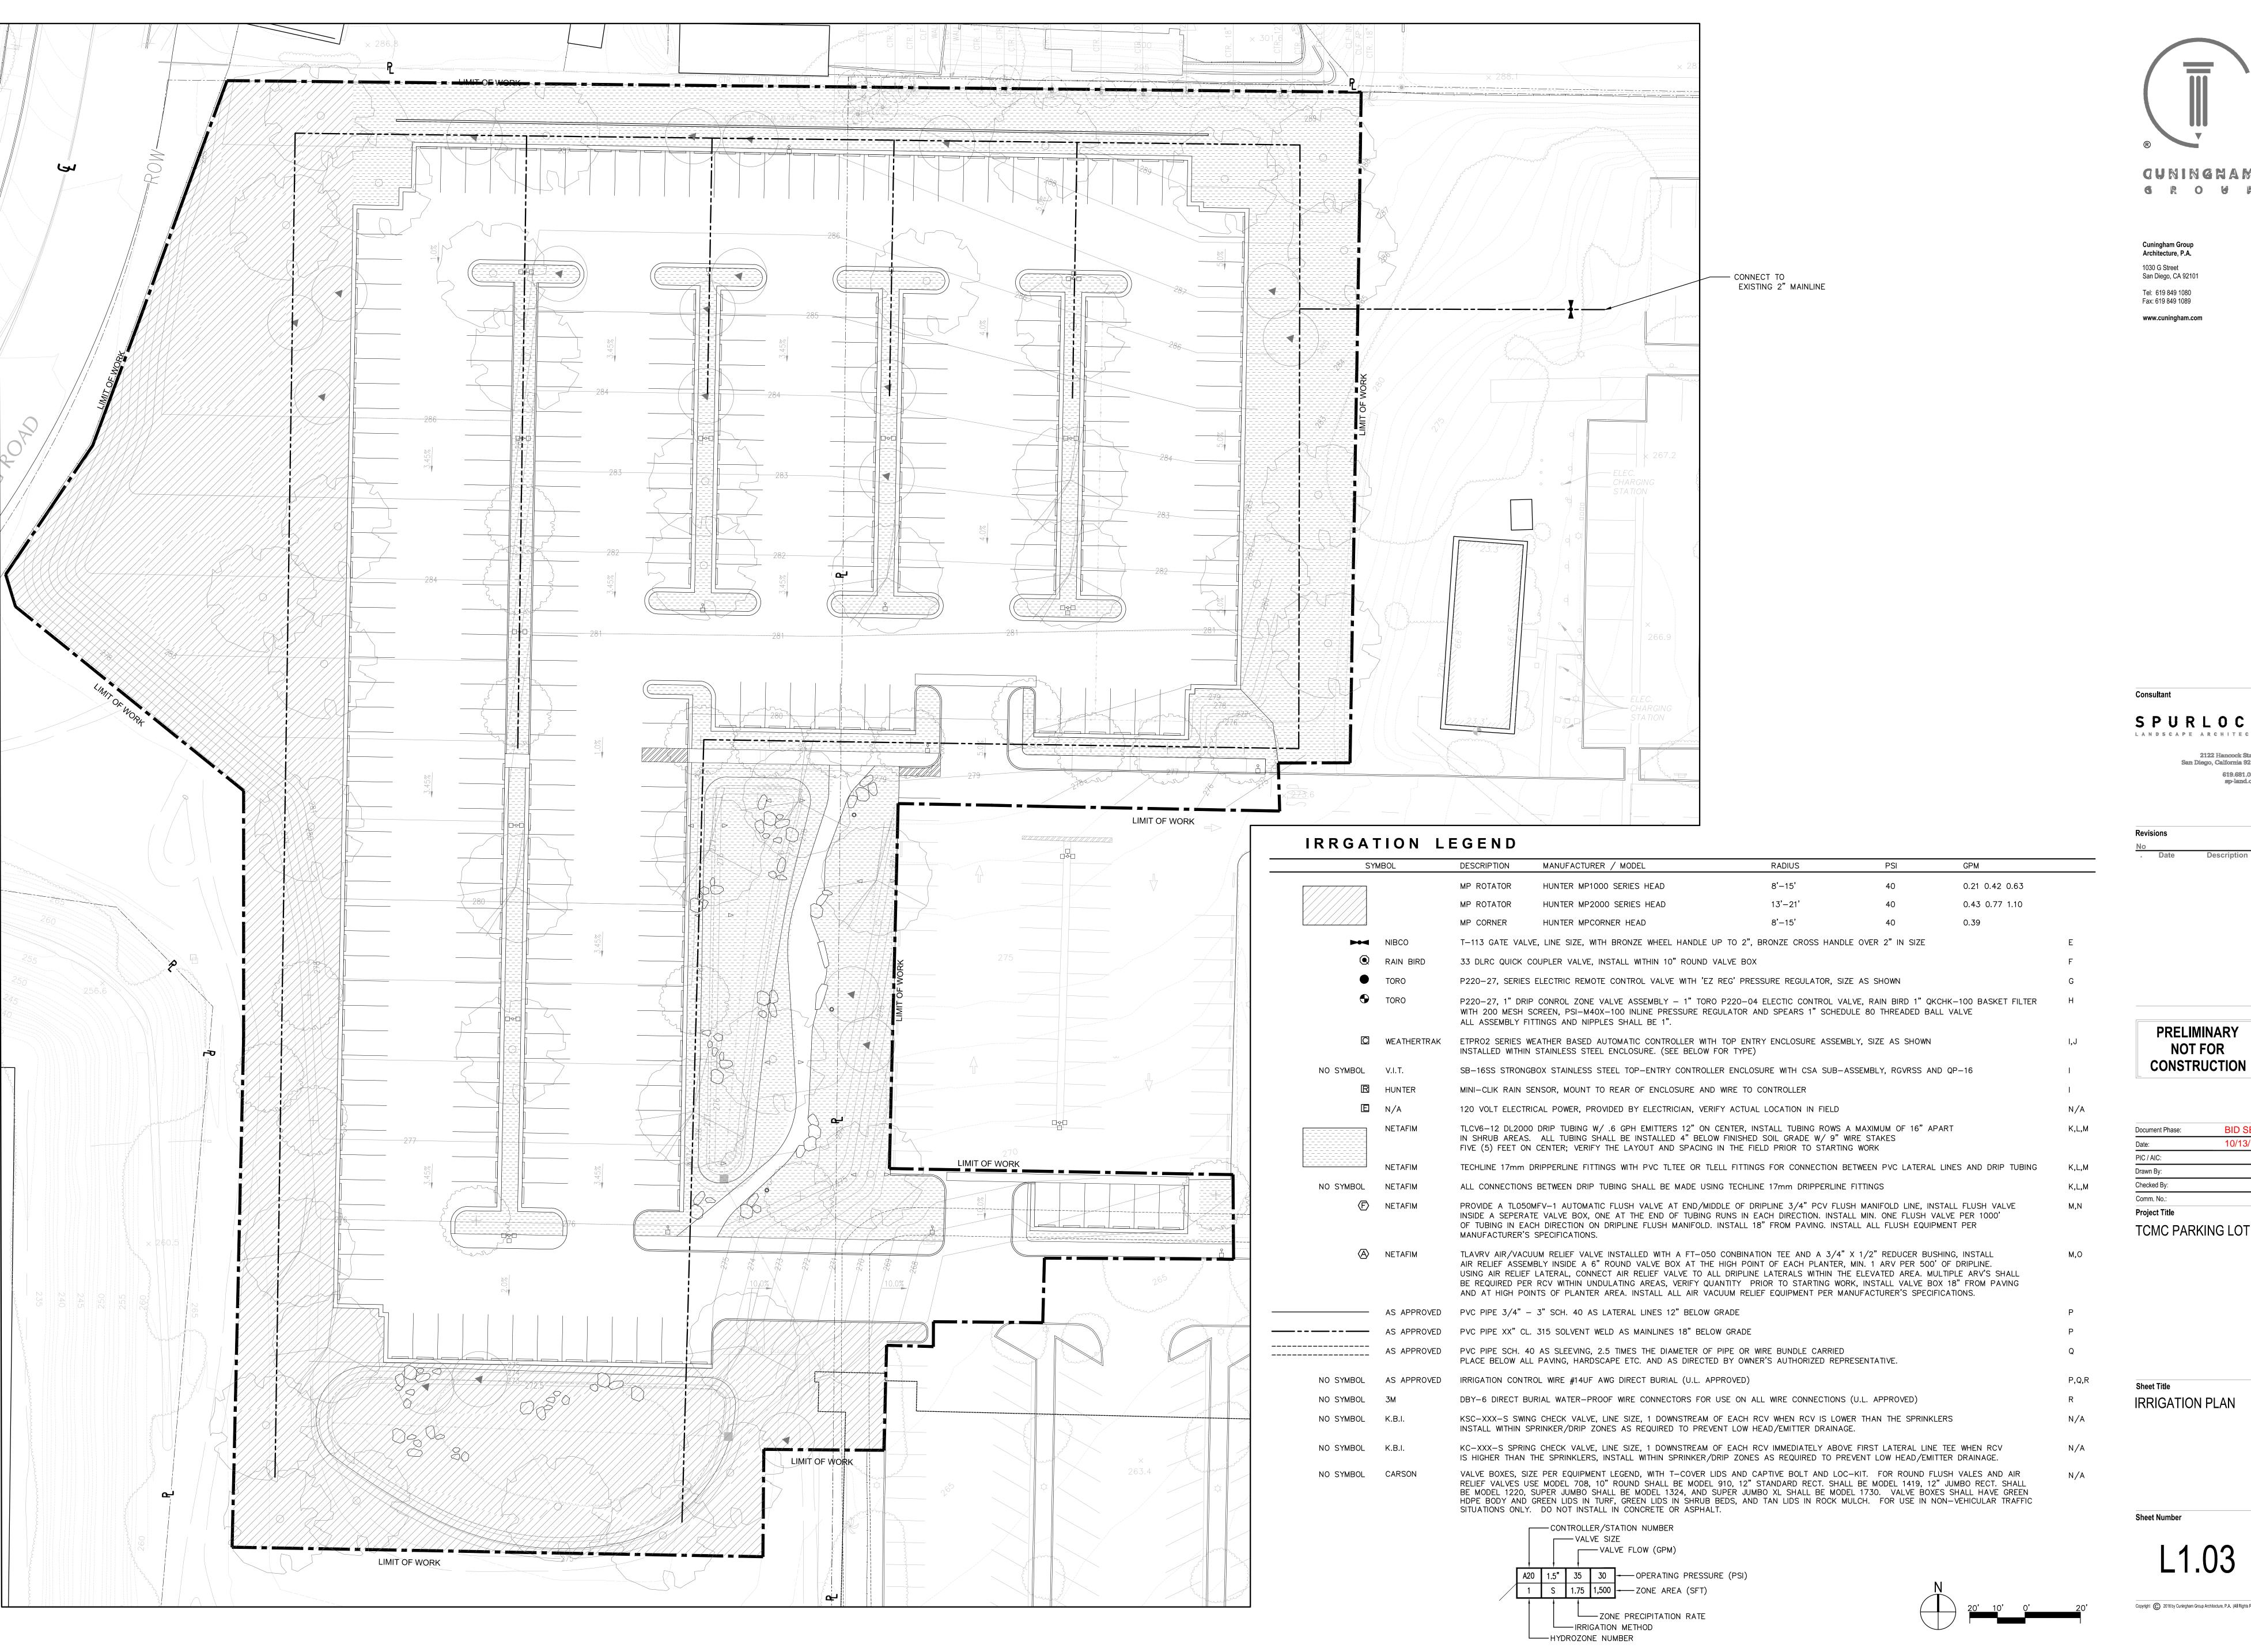
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TCMC PARKING LOT

NOTES AND LEGEND

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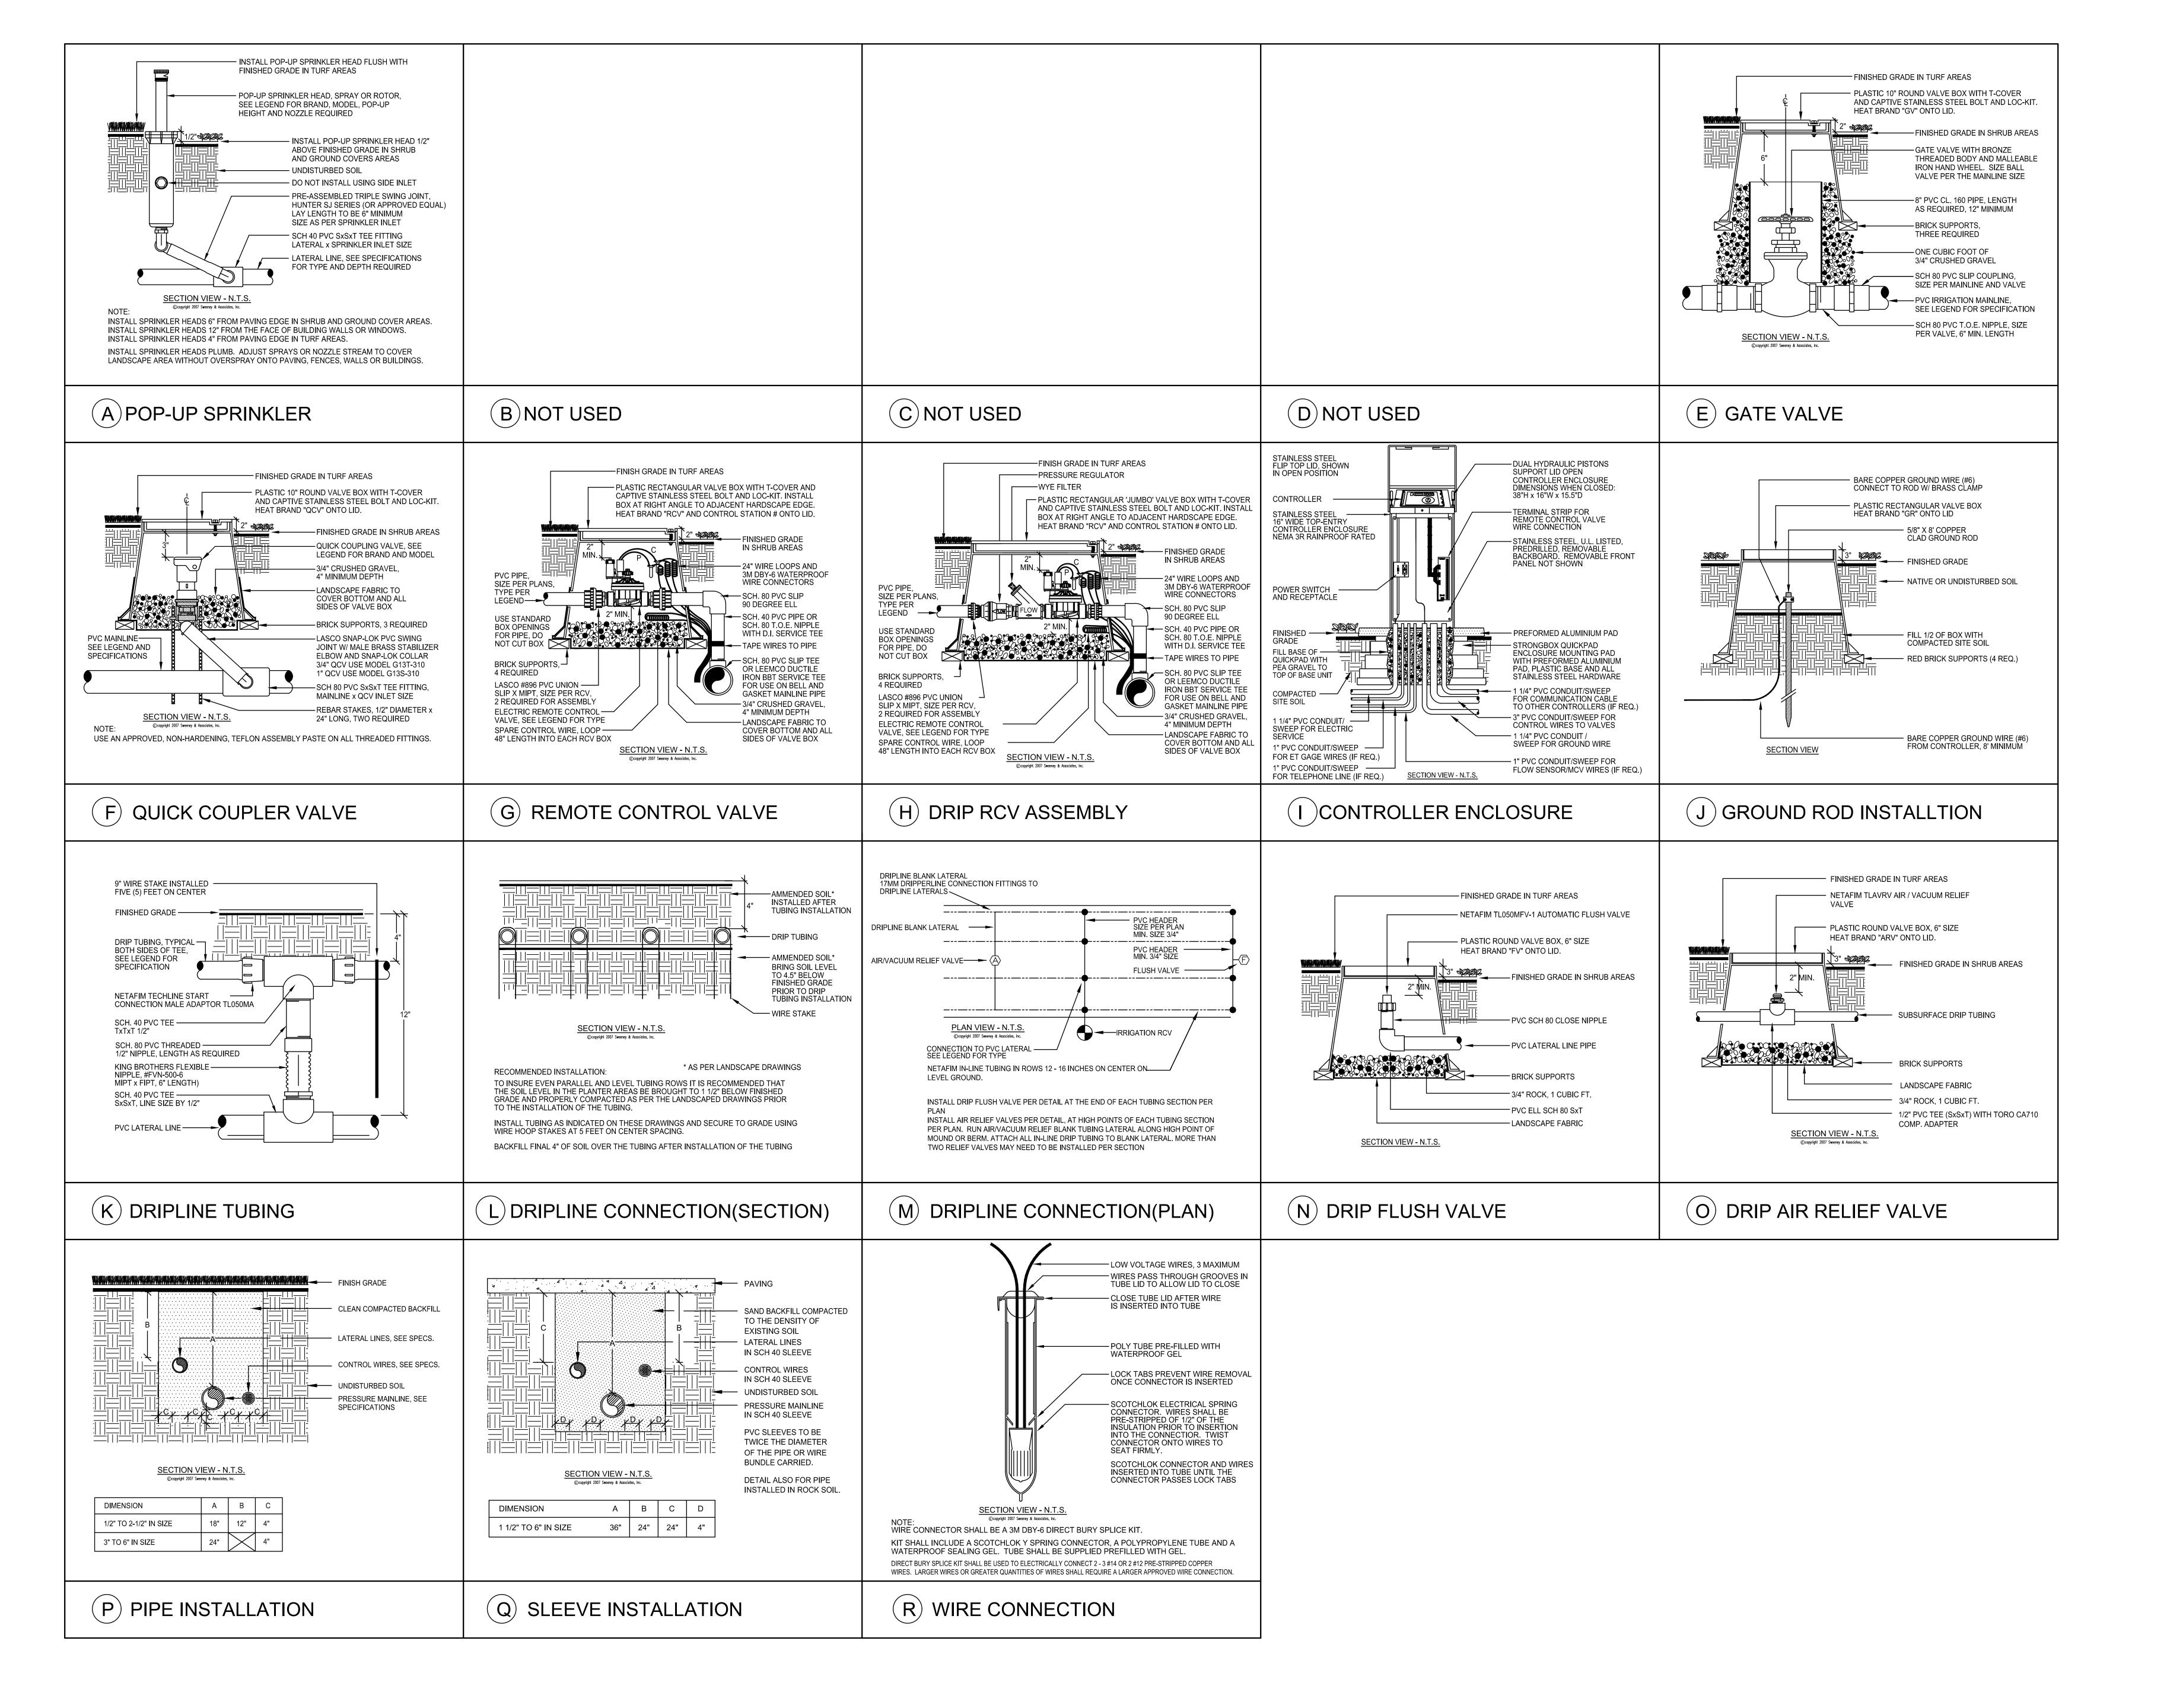
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IRRIGATION PLAN

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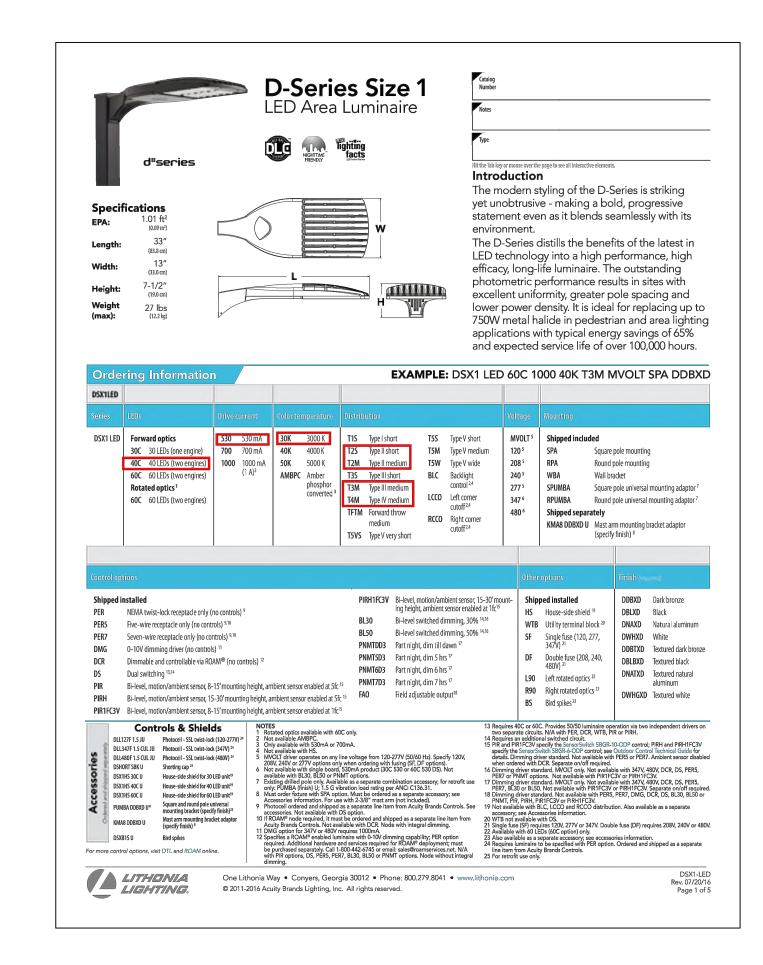
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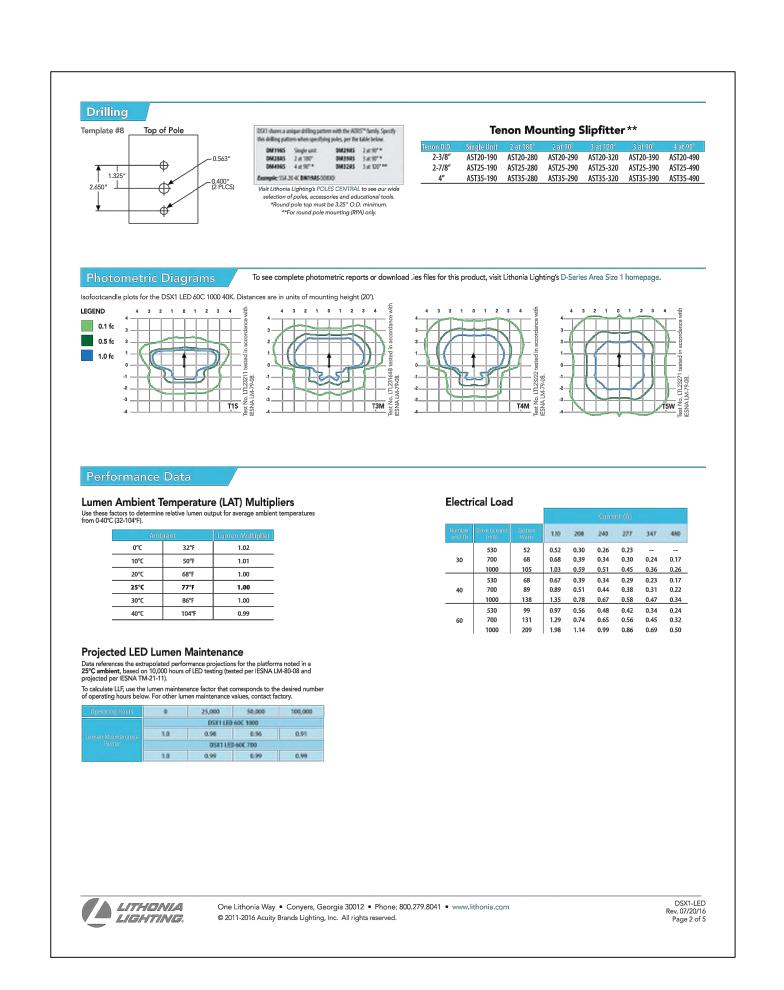
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FIXTURE CUT SHEETS





SYMBOLS AND ABBREVIATIONS

<u>CIRCUITS</u>

RACEWAY CONCEALED IN CEILING OR WALL. HASH MARKS INDICATE NUMBER OF WIRES. #12 AWG WIRE UNLESS OTHERWISE NOTED. EXPOSED RACEWAY IS ALLOWED ONLY WHERE NOTED.

— NEUTRAL (LONG HASH MARK)

GROUND WIRE (JOGGED HASH MARK) EXISTING RACEWAY (IF HASH MARKS ARE SHOWN, PULL NEW CONDUCTORS)

--- RACEWAY BELOW SLAB OR UNDERGROUND ----- RACEWAY UP

RACEWAY DOWN

RACEWAY STUB-OUT WITH BUSHING

HOME RUN TO PANEL OR LOCATION NOTED

JUNCTION BOX

PB

DUPLEX RECEPTACLE 120V

RECEPTACLE TYPES

DEDICATED CIRCUIT d GROUND FAULT CIRCUIT INTERRUPTER

GROUND FAULT CIRCUIT INTERRUPTER AND TAMPER RESISTANT

WP GROUND FAULT CIRCUIT INTERRUPTER WITH WEATHER PROOF

SITE AND LANDSCAPE LIGHTING LIGHTING STANDARD: FIXTURES, POLE, AND BASE

N/A ■ • IN-GROUND FIXTURE N∕A 📵 🚳 AIMED IN-GROUND FIXTURE

N/A ੈ 🍮 EXTERIOR RECESSED ACCENT FIXTURE N/A ♣ ♣ EXTERIOR SURFACE MOUNTED ACCENT FIXTURE N/A & EXTERIOR SEMI-RECESSED ACCENT FIXTURE

N/A • EXTERIOR DOWNLIGHT FIXTURE N/A ▼ EXTERIOR MONOPOINT FIXTURE

ELECTRICAL RISER

-- FEEDER SIZE IDENTIFICATION

TRANSFORMER

— AVAILABLE FAULT CURRENT IDENTIFICATION

<u>PANELBOARDS</u>

208V SYSTEM PANELBOARD

480V SYSTEM PANELBOARD

SINGLE POLE SWITCH

LIGHTING SWITCHES AND CONTROLS

LOWER-CASE LETTER NEAR SWITCH DENOTES CIRCUIT CONTROLLED (TYP)

WORK DEFINITION

FLAG NOTE

REVISION IDENTIFICATION # EQUIPMENT IDENTIFICATION

EQUIPMENT IDENTIFICATION DETAIL REFERENCE

DETAIL REFERENCE W/ORIGINATING SHEET REFERENCE

SECTION REFERENCE

SECTION REFERENCE W/ORIGINATING SHEET REFERENCE

ELEVATION REFERENCE

PROJECT NORTH REFERENCE W/TRUE NORTH REFERENCE ---- NEW WORK ----- EXISTING

GENERAL NOTES

1. COMPLY WITH THE CALIFORNIA ELECTRICAL CODE AS ADOPTED AND AMENDED BY THE LOCAL AUTHORITY HAVING JURISDICTION. 2. THE LOCATIONS OF ELECTRICAL DEVICES OR LIGHTING FIXTURES INDICATED ON ARCHITECTURAL PLANS

ELEVATIONS OR SECTIONS TAKE PRECEDENCE OVER LOCATIONS INDICATED ON THE ELECTRICAL

3. REFER TO THE ARCHITECTURAL REFLECTED CEILING PLANS FOR EXACT LIGHTING FIXTURE LOCATIONS. 4. FOR LIGHTING CONTROLS WHICH INCLUDE DAYLIGHT OR OCCUPANT SENSING AUTOMATIC CONTROLS, AUTOMATIC SHUT-OFF CONTROLS, OCCUPANCY SENSORS, OR AUTOMATIC TIME SWITCHES THE LIGHTING CONTROLS SHALL BE TESTED TO ENSURE THAT CONTROL DEVICES, COMPONENTS, EQUIPMENT, AND SYSTEMS ARE CALIBRATED, ADJUSTED, AND OPERATE IN ACCORDANCE WITH PROJECT PLANS AND SPECIFICATIONS. SEQUENCE OF OPERATION SHALL ALSO BE FUNCTIONALLY TESTED TO ENSURE IT IS OPERATING IN ACCORDANCE WITH PROJECT PLANS AND SPECIFICATIONS. A COMPLETE REPORT OF TEST PROCEDURES AND RESULTS SHALL BE PREPARED AND FILED WITH THE

<u>ABBR</u>	EVIATIONS		
ABV	ABOVE	MCC	MOTOR CONTROL CENTER
AC	3" ABOVE COUNTER BACKSPLASH	MDF	MAIN DISTRIBUTION FRAME/FACILITY
ACH	ABOVE COUNTER HEIGHT	MH	MANHOLE
AFF	ABOVE FINISHED FLOOR	ММ	MULTIMODE
AG	ABOVE GRADE	MTD	MOUNTED
A,AMP	AMPERE	MW	MICROWAVE
A/V	AUDIO/VISUAL	N	NEUTRAL
ATS	AUTOMATIC TRANSFER SWITCH	NIC	NOT IN CONTRACT
AWG	AMERICAN WIRE GAUGE	OPER	OPERATER/OPERABLE
CATV	COMMUNITY ACCESS TELEVISION	OPOI	OWNER PROVIDED OWNER INSTALLED
СВ	CIRCUIT BREAKER	PB	PULLBOX
CCTV	CLOSED CIRCUIT TELEVISION	PNL	PANEL, PANELBOARD
CKT	CIRCUIT	POS	POSITION/POINT OF SALE
CLG	CEILING	PR	PAIR
СМ	CEILING MOUNTED	PTS	PNEUMATIC TUBE STATION
СОММ	COMMUNICATIONS	R	RACEWAY
С	CONDUIT	RO	RACEWAY ONLY
СО	CONDUIT ONLY	RECEPT	
CTRL	CONTROL	REF	REFRIGERATOR
CU	COPPER	SLV	
D	DATA	SM	SINGLEMODE
DED	DEDICATED	SPECS	
DEV	DEVICE	SW	SWITCH
DN	DOWN	SWBD	SWITCHBOARD
DW	DISHWASHER	TELECOM	
EWC	ELECTRIC WATER COOLER	TGB	TELECOMMUNICATIONS GROUNDING
FA	FIRE ALARM		BUSBAR
FB	FLOOR BOX	TMGB	TELECOMMUNICATIONS MAIN
FBOIC	FURNISHED BY OTHERS, INSTALLED		GROUNDING BUSBAR
	BY CONTRACTOR	TSER	TELECOMMUNICATIONS SERVICE
FI	FILM ILLUMINATOR		ENTRANCE ROOM
FO	FIBER OPTIC(AL)	TV	TELEVISION
FOC	FACE OF COLUMN	TYP	TYPICAL
G,GND	GROUND	UF	UNDER FLOOR
GD	GARBAGE DISPOSAL	UG	UNDER GROUND
GFI,GFCI	GROUND FAULT CIRCUIT	UON	UNLESS OTHERWISE NOTED
	INTERRUPTER	UTP	UNSHIELDED TWISTED PAIR
НН	HAND HOLE	٧	VOLT OR VOICE
HP	HORSEPOWER	VEL	VERIFY EXACT LOCATION

OUTLET MOUNTING	HEIGHTS
DRAWINGS. IF SPECIAL OUTLET HEIG	WN ON THE ELECTRICAL DRAWINGS OR ON THE ARCHITECTURAL SHTS ARE NOT SHOWN OR REQUIRED, THEN LOCATE OUTLETS AS E MEASURED FROM THE FINISHED FLOOR TO THE CENTERLINE OF STED.
RECEPTACLES	18 INCHES (460 mm) VERTICALLY MOUNTED
SWITCHES	43 INCHES (1095 mm) VERTICALLY MOUNTED

WIRE, WATT, OR WALLPHONE

WIRELESS ACCESS POINT

WEATHERPROOF

PHASE

72 INCHES (1830 mm) TO TOP OF PANELBOARD IF BOX < 68

INCHES (1730 mm) HIGH, OTHERWISE PER NEC 404.8

INTERMEDIATE DISTRIBUTION

INSTA-HOT WATER DISPENSER

FRAME/FACILITY

JUNCTION BOX

MAGNETIC

PANELBOARDS



CUNINGNAM GROUP


Architecture, Inc. 1030 G Street San Diego, CA 92101 Tel: 619 849 1080 Fax: 619 849 1089

Cuningham Group



9191 Towne Centre Drive Suite 220 San Diego California 92122-6299

Consultant

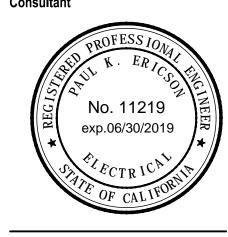

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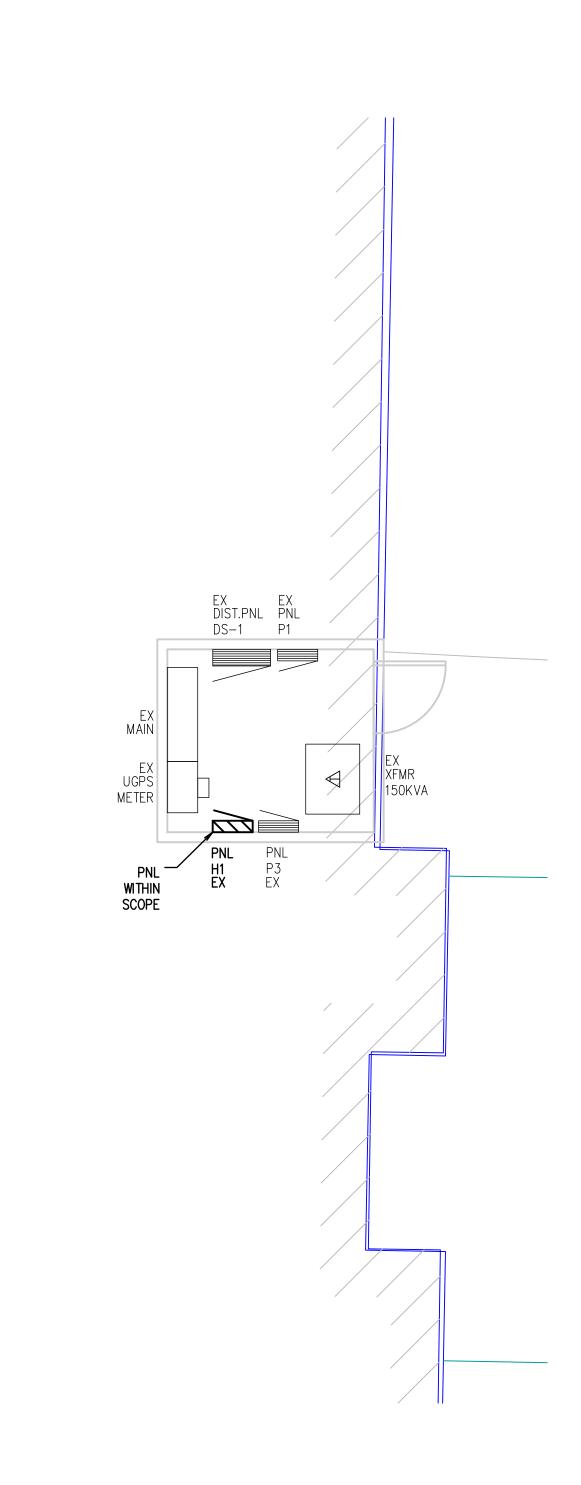
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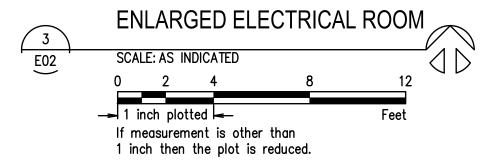
TCMC PARKING


Project Title

SYMBOLS AND **ABBREVIATIONS**

Sheet Number






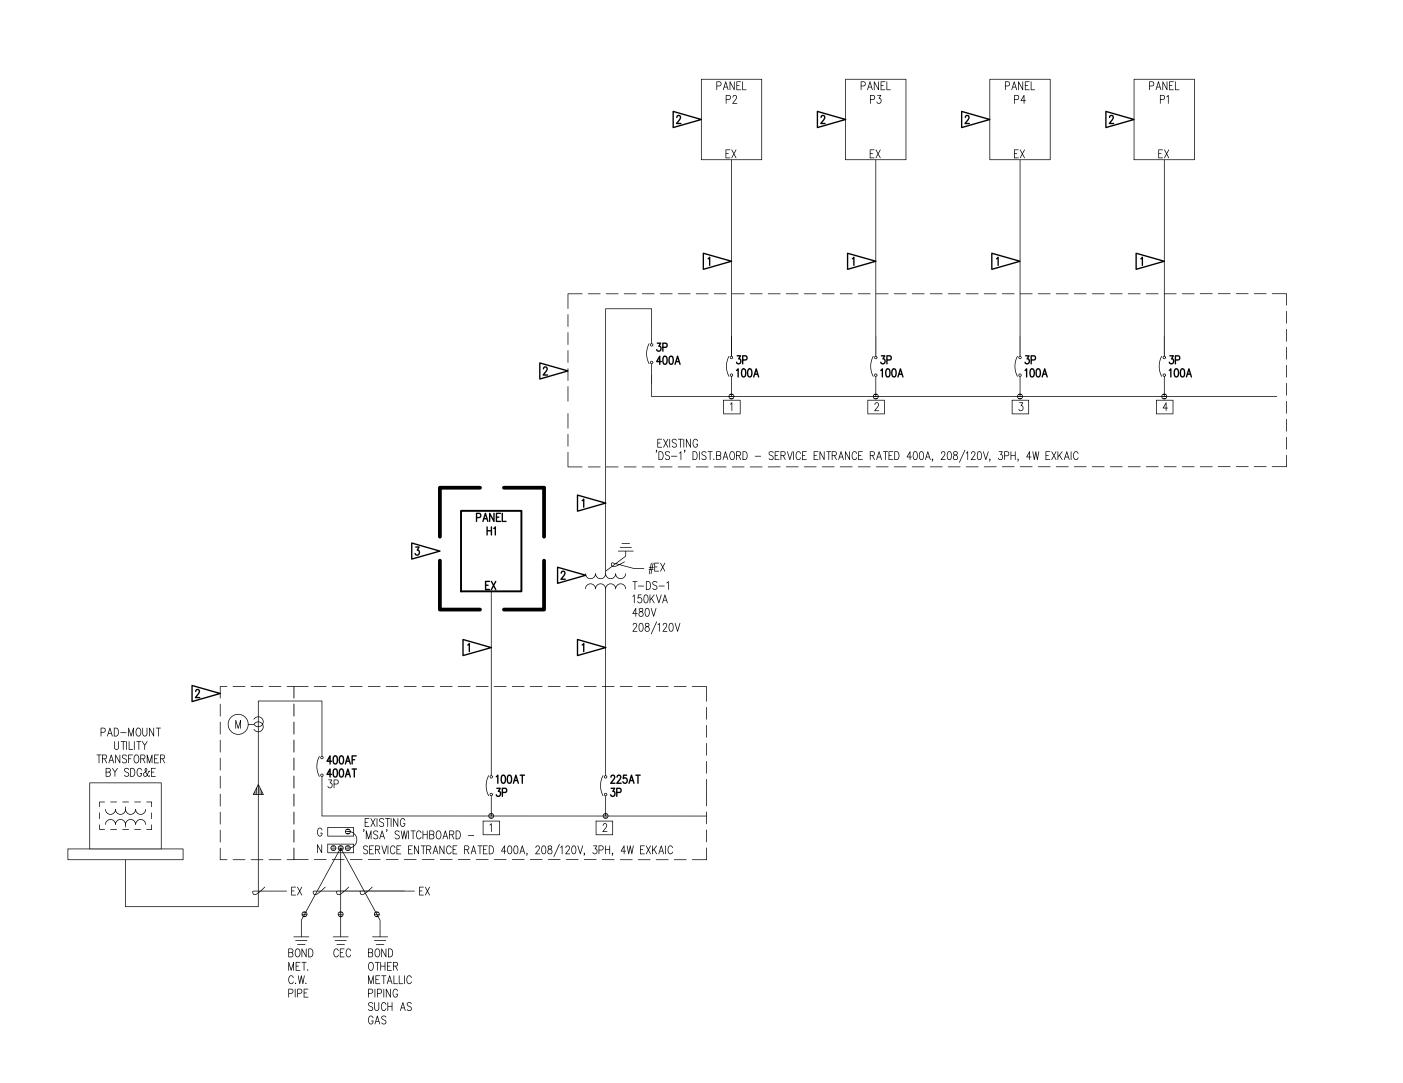



Stante Name Location Serves	H1 277/480V	3 PH	4W		n lugs or face Mou		Type: Panelbo 0 AIC	Panel ard
#	Description	Load	СВ	* A B C		* Loa	d Description	#
1	Lighting EXIT SIGNS		20/1	X	20/1		23 Lighting 2ND LEVEL RESTROOM	2
3	Lighting 1ST FLOOR RESTROOM LTG		20/1	X	50/3		14 Mech HEAT PUMP#1	4
5	Lighting EXTERIOR LIGHTING		20/1				14HEAT PUMP#1	6
7	Lighting FIRST LEVEL NW		20/1	X	1		10HEAT PUMP#1	8
9	Lighting FIRST LEVEL CNTR	0.91	20/1	Х	40/3	3.3	20 Mech HEAT PUMP#2	10
11	Lighting FIRST LEVEL SW	0.46	20/1	>		3.2	20HEAT PUMP#2	12
13	Lighting SECOND LEVEL NORTH	0.65	20/1	Х		3.	20HEAT PUMP#2	14
15	Lighting SECOND LEVEL SOUTH	0.77	20/1	Х	40/3	2.9	90 Mech HEAT PUMP#3	16
17	Lighting SECOND LEVEL SOUTH	0.68	20/1	>		2.9	90HEAT PUMP#3	18
19	Spare	0.00	20/1	Х		2,9	90HEAT PUMP#3	20
21	Lighting NEW EXTERIOR LIGHTING	0.00	20/1	Х	0/1	0.0	00 Space	22
23	Spare	0.00	20/1	>	0/1	0.0	00 Space	24
2 5	Spare	0.00	20/1	Х	0/1	0.0	XX Space	26
27	Spare	0.00	20/1	Х	0/1	0.0	XX Space	28
29	Space	0.00	0/1	· · · · · ·	0/1	0.0	00 Space	30
31	Space	0.00	0/1	Х	0/1	0.0	XX Space	32
3 3	Space	0.00	0/1	Х	0/1	0.0	XX Space	34
35	Space	0.00	0/1	>	0/1	0.0	XX Space	36
37	Space	0.00	0/1	Х	0/1	0.0	00 Space	38
39	Space	0.00	0/1	Х	0/1	0.0	XX Space	40
41	Space	0.00	0/1)	0/1	0.0	00 Space	42
Rev:	Rev: Revised Ckts Marked * Existing Ckts Marked # Co			PHA	РНВ	PHC	* Circuit Breaker Code	
Revise			cted KVA	14.45	13.55	14.15	G = GFCI H = HID Rated	
204530	204530031						S = Shunt Trip C = HACR Rate	đ
File:	V:\2045\active\204530031\Design\	Sched\TRN	AC PARKI	NG LOT.PN	4		D = Switching Duty # = See Note	
					<u> </u>		A = AFCI	
Notes:					Dem.			
Load T	······································	actor			***************************************			eed Amps
Lightin	_				7.57		9 x 125%	11
Mech	34.58 x 100%				34.58		12 125% of Largest	46

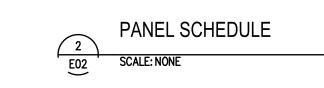



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FLAG NOTES:

EXISTING FEEDERS TO REMAIN.


2 EXISTING EQUIPMENT TO REMAIN.

BRANCH CIRCUIT/CIRCUITS BEING USED WITHIN SCOPE.

3> ELECTRICAL PANEL WITHIN SCOPE, SEE UPDATED PANEL SCHEDULE FOR NEW LOAD.

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Revisions
No
Date Description

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Date: 10/13/17
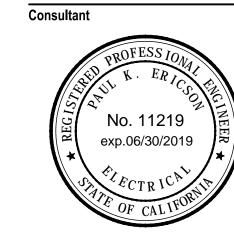
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Drawn By: JAK

Checked By: PKE

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Project Title


TCMC PARKING

LOT

Sheet Title
PANEL SCHEDULE &
SINGLELINE DIAGRAM

Sheet Number

E02

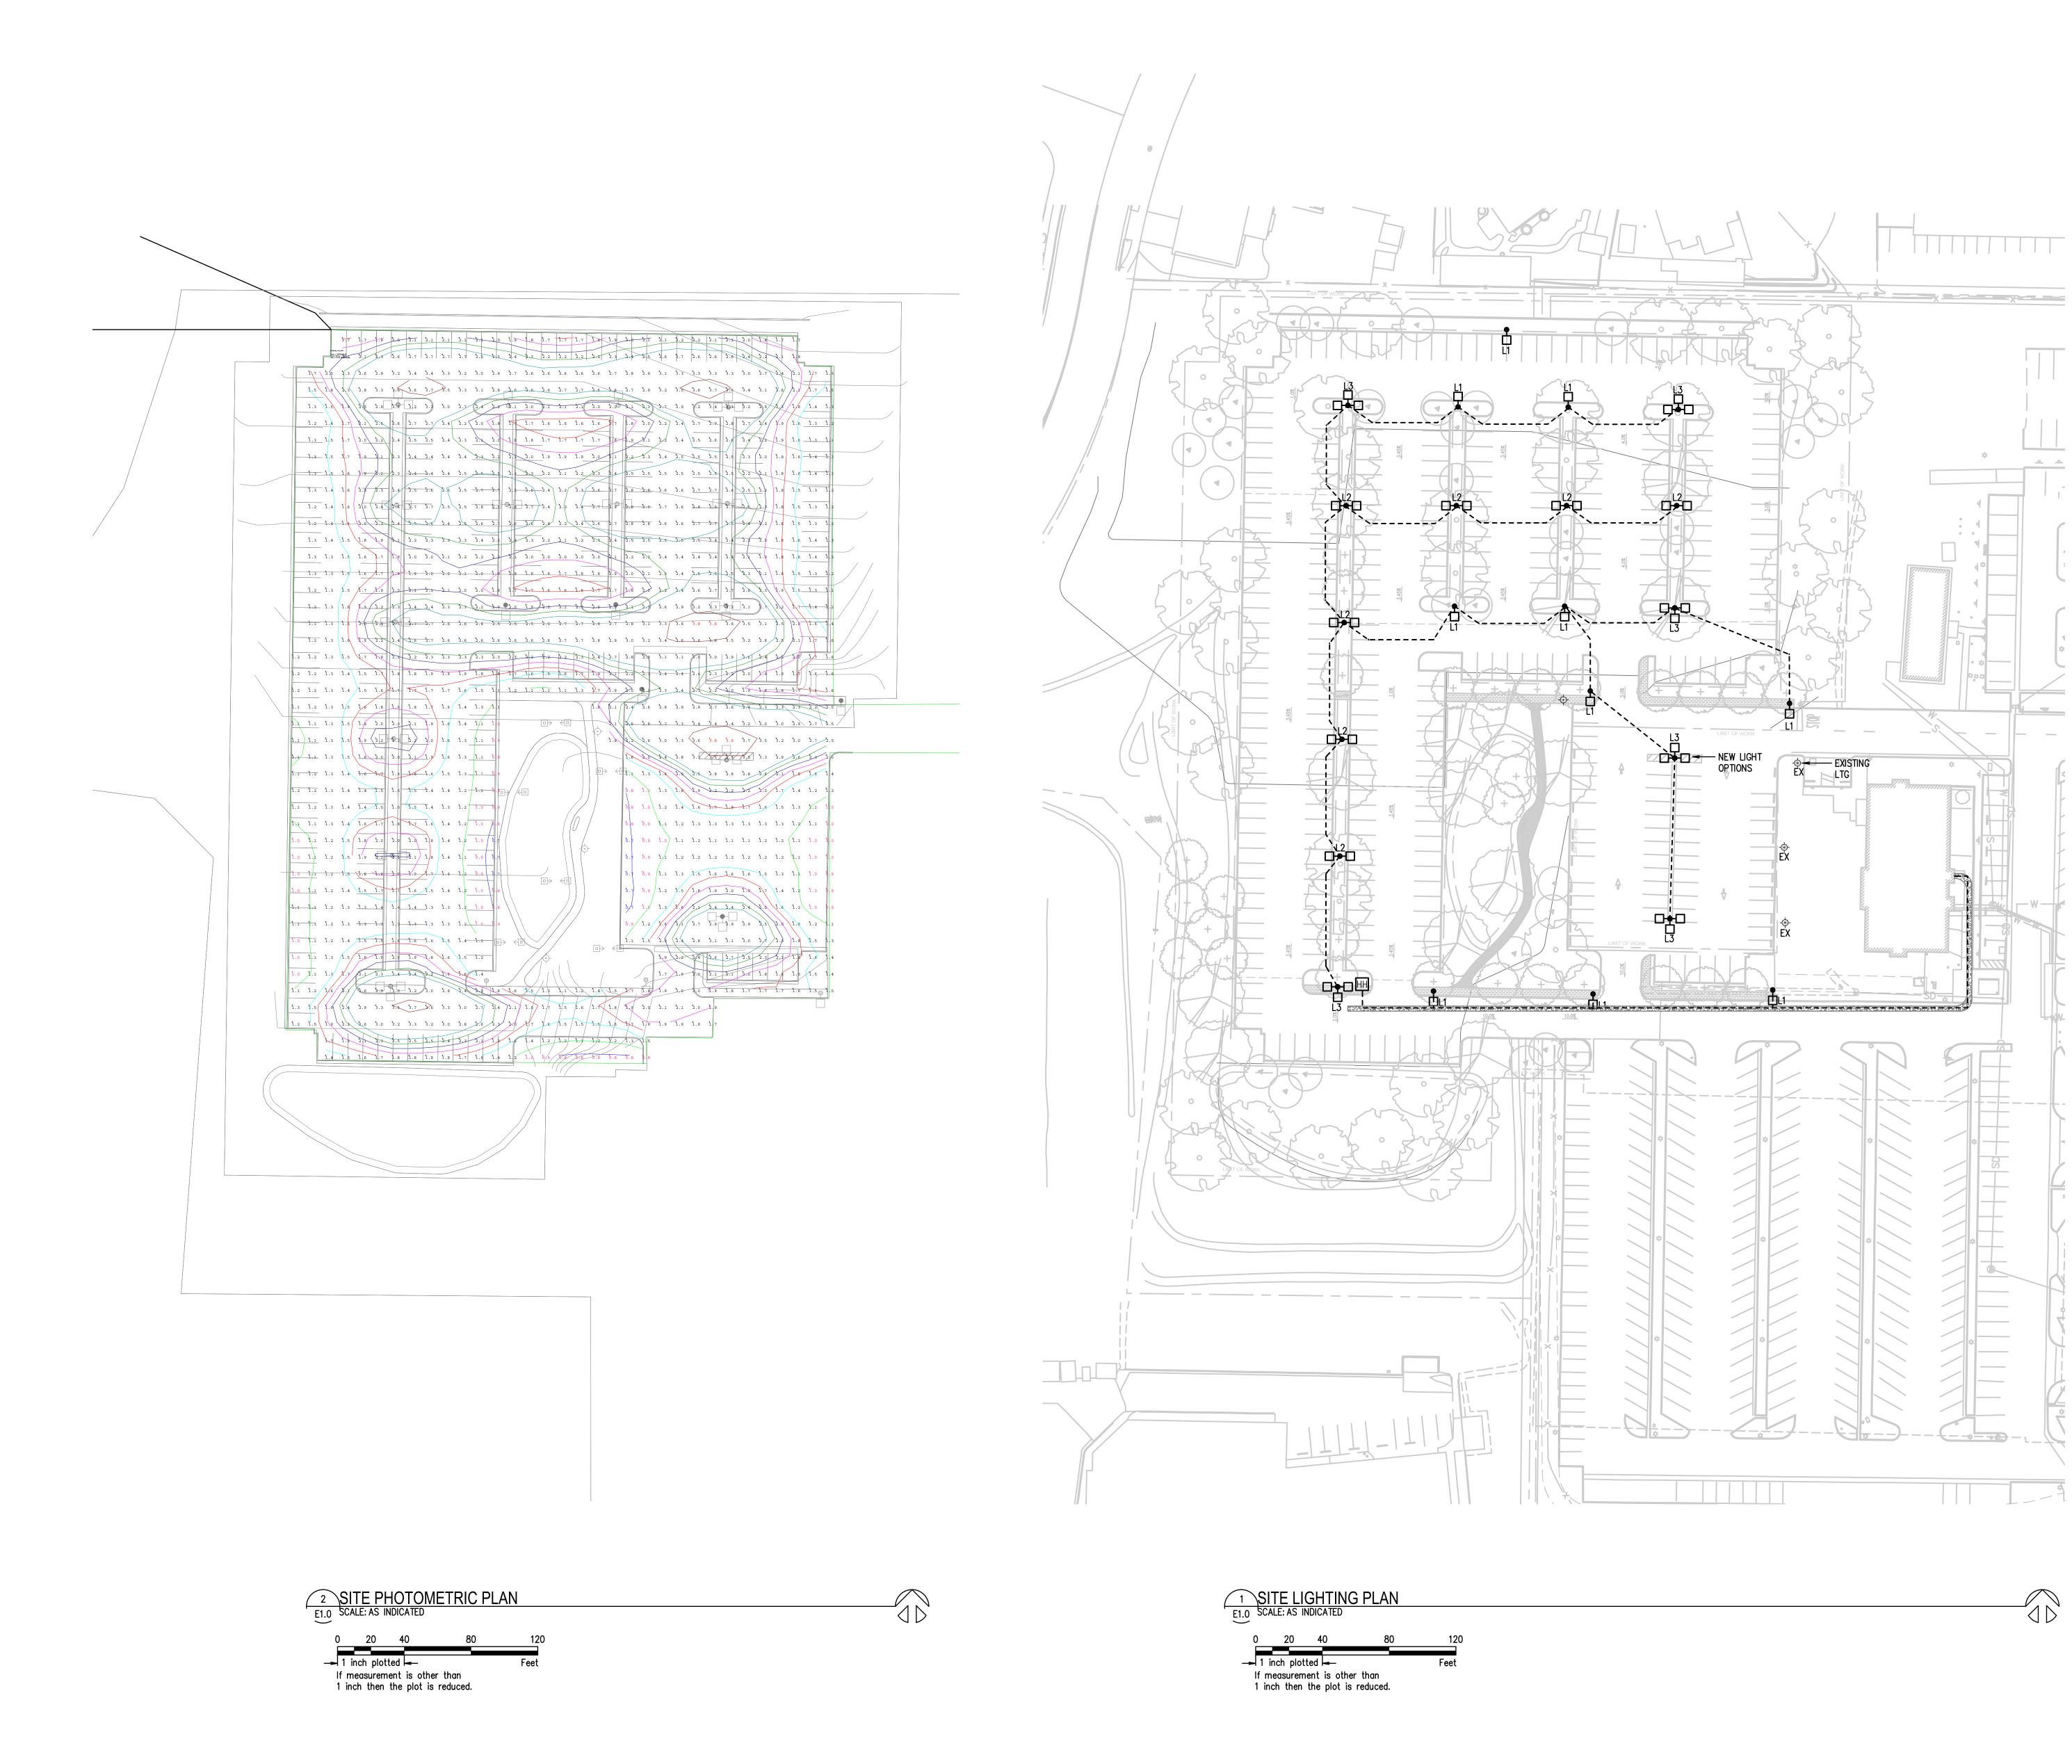



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> Sheet Title SITE LIGHTING & PHOTOMETRIC PLAN

Sheet Number

E1.0

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